STAFF REPORT

DATE: April 18, 2023

TO: City Council

FROM: Dianna Jensen, Director of Public Works - Engineering & Transportation/

City Engineer

Kevin Fong, Principal Civil Engineer

SUBJECT: Contract Award for Davis Community Park Pump Track and Categorical

Exemption per CEQA guidelines, CIP No. ET8311

Recommendation

Approve the attached resolution that:

- Awards the construction contract for the Davis Community Park Pump Track, CIP No. ET8311 to F. Loduca Company of Stockton, California, in the amount of \$392,622; and
- 2. Authorizes a 10% construction contingency of \$40,000; and
- 3. Authorizes the City Manager to sign the construction contract on behalf of the City.
- 4. Authorizes the City Manager to approve an additional \$40,000 (10%) for construction contingency if deemed necessary, and funding is available; and
- Finds that the Davis Community Park Pump Track Project is exempt from review pursuant to State CEQA Regulation Guidelines Section §15332 (14 Cal. Code Regs. § 15332) In-Fill Development Projects; and
- 6. Directs staff to file a Notice of Exemption pursuant to CEQA Guidelines Section 15332; and
- 7. Authorizes the allocation of \$4,319 towards the municipal arts fund; and
- 8. Approves the memorandum of understanding (MOU) with the Davis Bike Park Alliance (DBPA).

Fiscal Impact

The total estimated project cost is \$645,000 (Table 1). Design costs were incurred during 2018/2019 fiscal year and was paid for using Park Impact Fees. The remaining \$600,000 required to complete construction of the Davis Community Park Pump Track would be funded with ARP Revenue Replacement funds.

Table 1. Total Estimated Project Cost

Description	Amount
Design ¹	\$45,000
Construction Award	\$392,622
Construction Contingency	\$40,000
Construction Management and Inspection	\$104,159
Additional 10% Construction Contingency	\$40,000
Municipal Arts Fund (1.1%)	\$4,319

Materials Testing	\$15,000
Project Closeout	\$3,900
Total Estimated Project Cost	\$645,000

¹ Prior fiscal year expense

Table 2. Total Budget

Fund Description	Prior FY	Current FY	Total
Park Impact Fees (483)	\$45,000	\$0	\$45,000
ARP Revenue Replacement Funds	\$0	\$600,000	\$600,000
Total	\$45,000	\$600,000	\$645,000

Council Goal(s)

While this project does not address a specific task, it does support the City Council's Goal to Enhance a Vibrant Downtown and Thriving Neighborhoods.

Commission Input

Awarding construction contracts is a standard procedure where the City Council provides authority to award. During the design process, the Davis Community Pump Track project was brought to the Recreation and Parks Commission on September 19, 2018, and March 20, 2019 for input on the improvement plans.

Environmental

The City of Davis evaluated the potential environmental impacts for the project and prepared a notice of Categorical Exemption (CE), pursuant to CEQA requirements.

The project meets the criteria of Section 15332 for the following reasons:

- 1. The project is consistent with the applicable general plan designation and all applicable general plan policies as well as with the applicable zoning designation and regulations; and
- 2. The project site is located in City limits on a property that is less than 5 acres; and
- 3. The project site is a vacant former mill site that does not contain habitat for rare, threatened, or endangered species; and
- 4. The project proposes a small bike park that does not have the potential for significant impacts related to traffic, noise, air quality, or water quality; and
- 5. The site can be served by all required utilities and public services.

A Notice of Exemption will be filed by staff pursuant to CEQA Guidelines Section 15332.

Background and Analysis

The Davis Bike Park Alliance (DBPA) approached staff late in 2017 in hopes of building a Demonstration Bike Track. The group has met with City staff multiple times to review the Project Plan and to learn more about their bigger vision of creating a larger park as outlined in the Bicycle Action Plan as included in the City of Davis Beyond Platinum Bicycle Action Plan.

The Davis Bike Park Alliance is a non-profit 501(c)3 organization comprised of enthusiastic cyclists and recreationists working together with other trail users and land managers to create, maintain, and preserve natural surface cycling trails. Members of the DBPA include professionals within the local bicycle industry, engineers, and other members of the local Davis community with rich experience riding and building similar projects.

On December 5, 2017, Council selected Community Park as the site location for the Bike Pump Track project. On March 1, 2018, staff noticed a request for proposals to firms for the design portion of the bike pump track at Community Park. On March 14, 2018, Stantec, Inc. submitted a proposal totaling \$39,510. No other proposals were received, and Stantec demonstrated expertise and knowledge of bike pump track designs, as well as multiple references, and previous projects completed. On March 22, 2018, the City Manager awarded the design contract to Stantec, Inc.

On March 1, 2019, Stantec submitted 100% design plans, and a cost estimate for City review, and staff would like to provide an opportunity for the Recreation and Parks Commission, and the public to review the 100% design drawings. The project was advertised for bid on June 30, 2019 and bids were opened on July 25, 2019 at 2:00 P.M. Bids received at the July 25, 2019 bid opening were higher than anticipated, and all bids were rejected by at the September 10, 2019 Council meeting. During COVID, the project was defunded in order to preserve existing funding due to the unknown impact of COVID 19, and would be re-bid once the project was allocated funding.

Maintenance of the bike pump track would be a combination of effort with the City staff, and the DBPA. The responsibilities for both the City, and DBPA are listed in the MOU, and annual meetings would be required in order to address any issues or concerns. The MOU automatically renews on an annual basis unless terminated, and the DBPA would primarily be responsible for maintaining the pump track area. Staff worked with the DBPA on finalizing MOU after the project was defunded in order to have the MOU ready for approval once the project received funding, and was awarded for construction. The City Attorney, and risk management also reviewed, and approved the MOU.

As part of the utilization of Revenue Replacement funds, the Davis Community Park Pump Track was allocated \$600,000 for FY 22/23, and the project was noticed for bids on February 17, 2023. The following bids were received at the March 16, 2023 bid opening:

Table 3. Received Bids

Bidder	Base Bid
F. Loduca Company	\$392,622.00
Lister Construction, Inc.	\$483,437.05
BRCO Constructors, Inc.	\$558,775.00
Engineer's Estimate	\$400,000

Staff recommends adopting the attached resolution which awards the construction contract to F. Loduca Company in the amount of \$392,622, and 10% construction contingency for the Davis Community Pump Track Project, CIP No. ET8311, utilizing the funding as discussed above in fiscal impact, and enter into a MOU with the DBPA.

Attachments

- 1. Resolution
- 2. Project Plans
- 3. MOU

RESOLUTION NO. 23-XXX, SERIES 2023

RESOLUTION AWARDING CONSTRUCTION CONTRACT TO F. LODUCA COMPANY FOR THE DAVIS COMMUNITY PARK PUMP TRACK, CIP NO. ET8311, AND FINDING PROJECT EXEMPT FROM REVIEW PURSUANT TO CEQA GUIDELINES SECTION §15332 IN-FILL DEVELOPMENT PROJECTS AND EXECUTING A MEMORANDUM OF UNDERSTANDING WITH DAVIS BIKE PARK ALLIANCE

WHEREAS, the City of Davis did prepare plans, specifications and estimate, and the City of Davis did call for bids for Davis Community Park Pump Track, CIP No. ET8311; and

WHEREAS, City Staff did publicly open and read three submitted bids at 2:00 p.m., on March 16, 2023; and

WHEREAS, it has been determined that the lowest responsible bidder responsive to the plans and specifications is F. Loduca Company, of Stockton, California, whose bid is \$392,622; and

WHEREAS, the April 18, 2023 staff report provides supporting information upon which the declaration and findings set forth in this Resolution are based; and

WHEREAS, City Staff worked with the Davis Bike Park Alliance on a memorandum of understanding to participate in and provide support for routine inspection and maintenance of the Davis Community Park Pump Track; and

WHEREAS, the City Attorney and Risk Management reviewed and approved the memorandum of understanding.

NOW, THEREFORE, BE IT RESOLVED that the City Council of the City of Davis does hereby resolve as follows:

- 1. The City Council of the City of Davis does hereby award the construction contract for the Davis Community Park Pump Track, CIP No. ET8311 to F. Loduca Company of Stockton, California, in the amount of \$392,622; and
- 2. The City Manager is authorized to execute the contact; and
- 3. The sum of \$40,000 is hereby allocated from project funds for contingency purposes; and
- 4. The sum of \$40,000 is hereby allocated from project funds for additional contingency purposes if needed and approved by the City Manager; and
- 5. The sum of \$4,319 is hereby allocated from project funds for the municipal arts fund; and

- Find that the Davis Community Park Pump Track Project is exempt from review pursuant to State CEQA Regulation Guidelines Section §15332 (14 Cal. Code Regs. § 15332) In-Fill Development Projects; and
- 7. Direct staff to file a Notice of Exemption pursuant to CEQA Guidelines Section 15332; and
- 8. Authorizes the City Manager to enter into a memorandum of understanding with the Davis Bike Park Alliance to participate in and provide support for routine inspection and maintenance of the Davis Community Park Pump Track; and
- 9. All terms, conditions and covenants of said contract be and the same are hereby approved, ratified, and confirmed.

PASSED AND ADOPTED by the City Council of the City of Davis on this 18th day of April, 2023, by the following vote:

AYES:	
NOES:	
ATTEST:	Will Arnold Mayor
Zoe S. Mirabile, CMC	

City Clerk

IMPROVEMENT PLANS FOR DAVIS COMMUNITY PARK PUMP TRACK

1405 F STREET DAVIS, CA 95616

CITY OF DAVIS

COMMUNITY COMMUNITY PARK

VICINITY MAP

W COVELL BLVD W COVELL BLVD



DAVIS SENIOR

E 14TH STREET

SHEET INDEX

SHEET	DRAWING	TITLE
GENERAL:	G0.0	COVER SHEET
CIML: 2 3 4 5 6 7 8 9	C0.0 C1.0 C2.0 C3.0 C4.0 C5.0 C6.0 C6.1 C7.0	GENERAL NOTES EROSION CONTROL & DEMOLITION PLAN SITE LAYOUT PLAN FEATURE PLAN MATERIAL PLAN GRADING PLAN SECTIONS I SECTIONS II DETAILS
IRRIGATION 11 12	L1.0 L1.1	IRRIGATION PLAN IRRIGATION CALCULATIONS & NOTES
PLANTING: 13	L2.0	PLANTING PLAN
14 15 16	E DETAILS: L3.0 L3.1 L3.2 L3.3	LANDSCAPE DETAILS II LANDSCAPE DETAILS II LANDSCAPE DETAILS III LANDSCAPE DETAILS IV

Title COVER SHEET

PROJECT INFORMATION

PROJECT APPLICANT: PROJECT ADDRESS:

TOTAL LANDSCAPE AREA: 20,550 S.F.

PROJECT TYPE:

PARK RENOVATION

WATER SUPPLY TYPE: POTABLE CITY OF DAVIS

CHECKLIST OF ALL DOCUMENTS IN LANDSCAPE DOCUMENTATION PACKAGE: HYDROZONE INFORMATION TABLE (L1,1)
WATER BUDGET CALCULATIONS (MAWA & ETWA) (L1,1)
SOIL MANAGEMENT REPORT (SEE GEOTECHNICAL REPORT)
LANDSCAPE LAYOUT PLAN (LX.X) LANDSCAPE DESIGN PLAN (L2.0)
IRRIGATION PLAN (L1.0 THRU L1.1)

APPLICANT/OWNER: CITY OF DAVIS

"I AGREE TO COMPLY WITH THE REQUIREMENTS OF THE CITY OF DAVIS'S WATER EFFICIENT LANDSCAPE REQUIREMENTS AND SUBMIT A COMPLETE LANDSCAPE DOCUMENTATION PACKAGE,"

APPLICANT NAME

02/06/2019

GENERAL NOTES

1. ALL CONSTRUCTION SHALL CONFORM TO THE CITY OF DAVIS STANDARDS.
2. THE CONTRACTOR SHALL BE SOLELY AND COMPLETELY RESPONSIBLE FOR FURNISHING, INSTALLING AND MAINTAINING ALL WARNING SIGNS AND DEVICES NECESSARY TO SAFEGUARD THE GENERAL PUBLIC AND THE WORK, AND TO PROVIDE FOR THE PROPER AND SAFE ROUTING OF THE VEHICULAR AND PEDESTRIAN TRAFFIC DURING THE PERFORMANCE OF THE WORK, THIS REQUIREMENT SHALL APPLY CONTINUOUSLY AND NOT BE LIMITED TO NORMAL WORKING HOURS. THE USE OF FLAGMEN, BARRICADES AND CONSTRUCTION SIGNING SHALL COMPLY WITH THE CURRENT EDITION OF WORK AREA AND TRAFFIC CONTROL HANDBOOK (W.A.T.C.H.).
3. LOCATION OF UNDERGROUND FACILITIES ARE APPROXIMATE ONLY. THE CONTRACTOR SHALL BE RESPONSIBLE FOR DETERMINING THE EXACT LOCATION OF ALL EXISTING UTILITIES AND FOR THE PROTECTION OF AND REPAIR OR DAMAGE TO THEM. THE CONTRACTOR SHALL CONTACT UNDERGROUND FACILITIES ARE SERVICE ALERT (1—B00—642—2444) TWO (2) WORKING DAYS BEFORE WORK IS TO BEGIN.

(2) WORKING DAYS BEFORE WORK IS TO BEGIN. TEMPORARY CONSTRUCTION FENCE SHALL BE INSTALLED ALONG PROJECT LIMITS. SEE

SPECIFICATIONS FOR DETAILS.
 CONTRACTOR IS RESPONSIBLE FOR VISITING AND UNDERSTANDING SITE CONDITIONS AND LANDSCAPE IMPROVEMENT PLANS.
 CONTRACTOR IS RESPONSIBLE TO COMPLY WITH THE EROSION CONTROL NOTES.

MODEL WATER EFFICIENT LANDSCAPE ORDINANCE (MWELO) COMPLIANCE STATEMENT

I HAVE COMPLIED WITH THE CRITERIA OF THE CALIFORNIA MODEL WATER EFFICIENT LANDSCAPE ORDINANCE AND APPLIED THEM FOR EFFICIENT USE OF WATER IN THE LANDSCAPE DESIGN PLAN.

And a Marial -

02/06/2019

PAUL A. MARCILLAC, PLA 4095

04-18-23 @itynCouncil Meeting By Appd YTYLAMED

DATE



Stantec

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CITY OF DAVIS

DAVIS COMMUNITY PARK PUMP TRACK

File Norme: 222011228_COVER SHEET

Project No. 222011228 AS SHOWN Drawing No. Revision Sheet 1 of 17

04A - 7

1. THE LOCATIONS OF UNDERGROUND UTILITIES SHOWN ARE BASED ON DESIGN PLANS FROM THE ELECTRONIC SURVEY PROVIDED BY THE CITY. THE CONTRACTOR SHALL NOTIFY UNDERGROUND SERVICE ALERT AND THE PROPER LOCAL AUTHORITIES OR RESPECTIVE UTILITY COMPANIES TO CONFIRM THE LOCATION OF ALL EXISTING UTILITIES BEFORE COMMENCING WORK. ANY DAMAGE DUE TO FAILURE OF THE CONTRACTOR TO CONTACT THE PROPER AUTHORITIES SHALL BE BORNE BY THE CONTRACTOR.

2. CONTRACTOR SHALL VERIFY AND COORDINATE FINISH GRADES WITH RELATED SITE IMPROVEMENTS. CONTRACTOR SHALL IMMEDIATELY REPORT ANY CONFLICTS OR DISCREPANCIES TO THE LANDSCAPE ARCHITECT.

3. THE CONTRACTOR SHALL BE RESPONSIBLE FOR CONFIRMING GROUND ELEVATIONS AND OVERALL TOPOGRAPHY OF THE SITE, AS WELL AS, ALL SITE DIMENSIONS PRIOR TO START OF CONSTRUCTION. THE CONTRACTOR SHALL IMMEDIATELY NOTIFY THE ENGINEER IN WRITING OF ANY DIFFERENCES IN TOPOGRAPHY OR SITE DIMENSION THAT DIFFER FROM THOSE SHOWN ON THE PLANS.

4. WRITTEN DIMENSIONS ARE TO TAKE PRECEDENCE OVER SCALED DIMENSIONS. NOTIFY ENGINEER OF ANY DISCREPANCIES FOUND IN THE FIELD BEFORE MOVING FORWARD. FAILURE TO GAIN CLARIFICATION FROM ENGINEER BEFORE MOVING FORWARD WILL RENDER CONTRACTOR RESPONSIBLE FOR ALL COSTS ASSOCIATED WITH CORRECTING INSTALLED WORK TO THE SATISFACTION OF THE LANDSCAPE ARCHITECT.

5. CONTRACTOR SHALL BE RESPONSIBLE FOR REMOVING ALL DEBRIS FROM THE PROJECT SITE, AS NEEDED, DURING CONSTRUCTION.

6. CONTRACTOR SHALL PERFORM ALL WORK IN ACCORDANCE WITH ALL APPLICABLE LOCAL, STATE AND/OR NATIONAL BUILDING CODES AND REQUIREMENTS.

7. ALL WORK SHALL BE DONE IN ACCORDANCE WITH THE APPLICABLE FEDERAL, STATE AND LOCAL CODES, AND ALL REGULATIONS.

8. CONTRACTOR SHALL BE RESPONSIBLE FOR MAINTENANCE AND PROTECTION OF VEHICULAR AND PEDESTRIAN TRAFFIC. ALL TRAFFIC CONTROL MEASURES SHALL BE IN ACCORDANCE WITH LOCAL, STATE, AND OSHA REGULATIONS.

9. CONTRACTOR SHALL HAVE ALL REQUIRED SUBMITTAL APPROVALS PRIOR TO BEGINNING THE WORK OR ORDERING MATERIALS.

10. CONTRACTOR SHALL BE RESPONSIBLE FOR REPAIR TO ANY SIDEWALKS, LAWN, TREES, PAVING, AND OTHER IMPROVEMENTS DISTURBED BY CONSTRUCTION OR DEMOLITION ACTIVITIES PROPOSED HEREIN.

PUMP TRACK PERFORMANCE SPECIFICATIONS

ALL TRACK CONSTRUCTION SHALL COMPLY WITH THE SPECIFICATIONS, DRAWINGS, REQUIREMENTS, AND DESIGN INTENT PRESCRIBED IN THE CONSTRUCTION AND CONTRACT DOCUMENTS. ADDITIONAL RESOURCES INCLUDE "BIKE PARKS: IMBA'S GUIDE TO NEW SCHOOL TRAILS" (2014), "TRAIL SOLUTIONS" (2004), AND "MANAGING MOUNTAIN BIKING" (2007). MODIFICATIONS SHALL BE APPROVED BY OWNER'S REPRESENTATIVE.

- 1. COMPLETED PRODUCTS SHALL REFLECT PROFESSIONAL WORKMANSHIP IN APPEARANCE, QUALITY, AND ATTENTION TO DETAIL. TRAILS AND FEATURES SHALL BE WELL INTEGRATED INTO SITE, AESTHETICALLY PLEASING IN APPEARANCE, AND WELL-SHAPED, CRAFTED, AND FINISHED ACCORDING TO COMMONLY ACCEPTED BEST PRACTICES FOR HIGH QUALITY AND SUSTAINABLE MOUNTAIN BIKING TRAILS. WORK MUST BE COMPLETED TO THE SATISFACTION OF THE OWNER'S REPRESENTATIVE.
- 2. SHOULD THE CONTRACTOR DISCOVER DISCREPANCIES IN THE SPECIFICATIONS, THE MATTER SHALL BE AT ONCE BROUGHT TO THE ATTENTION OF THE OWNER'S REPRESENTATIVE, AND THE DISCREPANCIES CORRECTED BEFORE PROCEEDING FURTHER.
- 3. PUMP TRACK CONTRACTOR SHALL BE RESPONSIBLE FOR ANY COORDINATION WITH GENERAL CONTRACTOR AND SUBCONTRACTORS AS REQUIRED TO COMPLETE ALL OPERATIONS.
- 4. TEST RIDING: PUMP TRACK CONTRACTOR SHALL THOROUGHLY TEST RIDE THE PUMP TRACK BY BIKE WITH APPROPRIATE EXPERT RIDER, TO ENSURE THE SPECIFIED RIDING EXPERIENCE, DESIGN, FLOW, RHYTHM, CHARACTER, DIFFICULTY, AND SPECIFICATIONS ARE MET. TESTING SHALL BE PERFORMED DURING THE TRACK ALIGNMENT AND TRACK FEATURE LOCATION PROCESS, AS WELL AS DURING CONSTRUCTION AND FOLLOWING CONSTRUCTION, TO THE EXTENT POSSIBLE AND IN CONSULTATION WITH OWNER'S REPRESENTATIVE. TRACK AND ITS FEATURES SHALL BE MODIFIED AND CORRECTED AS NECESSARY UNTIL PERFORMANCE SPECIFICATIONS ARE MET.
- 5. PUMP TRACK CONTRACTOR SHALL LEAVE TRACK AND THE ADJACENT AREA IN A FINISHED AND NATURAL-LOOKING CONDITION AND MINIMIZE DISTURBANCE TO PERMANENT EXISTING VEGETATION TO THE EXTENT POSSIBLE IN COORDINATION WITH GENERAL CONTRACTOR, TOPSOIL SPREADING, IRRIGATION AND LANDSCAPE INSTALLATION.
- 6. ALL EXCAVATED MATERIAL GENERATED DURING PUMP TRACK CONSTRUCTION MUST BE USED IN THE TRAIL, OR DISPERSED AND BLENDED INTO SURROUNDING TERRAIN, OR REMOVED. NO PILES OF EXCAVATED MATERIAL GREATER THAN 6 INCHES DEPTH SHALL BE LEFT BEHIND.
- 7. THE PUMP TRACK CONTRACTOR SHALL BE RESPONSIBLE FOR FINE GRADING AND POSITIVE DRAINAGE AWAY FROM ALL TRAILS AND TRAIL FEATURES. NO IMPOUNDMENTS NOR PONDING OF SURFACE WATER SHALL BE ALLOWED.

100% CONSTRUCTION DRAWING

90% CONSTRUCTION DRAWINGS

Issued

By Appd YYYY.MM.DD

PUMP TRACK CONSTRUCTION NOTES

TRACK ALIGNMENTS

A. THE TRAIL PLAN IS DIAGRAMMATIC AND DOES NOT REFLECT AN EXACT FINAL ALIGNMENT OR DIMENSION FOR EACH TRAIL, TRAIL IMPROVEMENT, ARMORING, OR TRAIL FEATURE. ALL TRAIL AND TRAIL IMPROVEMENT LOCATIONS AND DIMENSIONS ARE APPROXIMATE.

B. PUMP TRACK CONTRACTOR SHALL CREATE AN EXACT FINAL ALIGNMENT AND LOCATION FOR EACH TRACK AND TRACK FEATURE. THE ALIGNMENTS AND LOCATIONS SHALL MEET APPROPRIATE SPECIFICATIONS AS PROVIDED IN THE CONSTRUCTION DOCUMENTS. TRACK ALIGNMENTS MUST BE FLAGGED IN THE FIELD PRIOR TO CONSTRUCTION.

C. THE ALIGNMENT, LOCATION, DESIGN, AND CONSTRUCTION OF EACH INDIVIDUAL TRAIL SHALL CONFORM TO THE SPECIFICATIONS, INTENT, CHARACTER, AND DESCRIPTION FOR THAT SPECIFIC TRAIL AS DESCRIBED IN THE CONSTRUCTION DOCUMENTS.

D. IF CONFLICTS ARISE IN TRAIL ALIGNMENTS, FEATURES, ARMORING, VEGETATION, LANDSCAPING, IRRIGATION, AND/OR OTHER ITEMS, TRAIL CONTRACTOR IS REQUIRED TO IMMEDIATELY CONTACT OWNER'S REPRESENTATIVE FOR RESOLUTION BEFORE PROCEEDING.

E. THE TRAIL CONTRACTOR SHALL WORK WITH THE OWNER'S REPRESENTATIVE TO IDENTIFY THE NEED TO FURTHER REFINE OR ADJUST CONSTRUCTION NOTES, LOCATION OR TYPES OF TRAILS OR FEATURES, AND MAKE MINOR ADJUSTMENTS AT THE TIME OF CONSTRUCTION.

2. TURNS

A. TURNS ON THE TRAIL SYSTEM SHALL BE CAMBERED/BANKED/BERMED AS NECESSARY ACCORDING TO THE SPECIFICATIONS, DRAWINGS, INTENDED RIDING EXPERIENCE, TRAIL FLOW, TRAIL SPEED, AND DIFFICULTY. TURN CONSTRUCTION SHALL BE INCIDENTAL TO THE UNIT RATE FOR TRAIL CONSTRUCTION.

3. VERTICAL UNDULATIONS

A. THE TRACK SHOULD HAVE VERTICAL UNDULATIONS SUCH AS ROLLERS, JUMPS, GRADE REVERSALS, AND DIPS AS NECESSARY ACCORDING TO THE SPECIFICATIONS, DRAWINGS, INTENDED RIDING EXPERIENCE, TRAIL FLOW, TRAIL SPEED, AND DIFFICULTY. SUCH VERTICAL UNDULATIONS SHALL BE INCIDENTAL TO THE UNIT RATE FOR TRAIL CONSTRUCTION.

4. COMPACTION

A. ALL TRACK, TRACK TREADS, TRACK SURFACING MATERIALS, BACKSLOPES, ROLLERS, BERMS, FILL, AND TERRAIN ENHANCEMENTS SHALL BE 95% COMPACTED ACCORDING TO COMMONLY ACCEPTED BEST PRACTICES AND IN A MANNER THAT WILL SUPPORT THE INTENDED USE

B. ALL SUB GRADES SHALL BE 90% COMPACTED ACCORDING TO ACCEPTED BEST PRACTICES.

C. ALL INSTANCES OF CLASS 2 AGGREGATE SHALL BE 95% COMPACTED ACCORDING TO ACCEPTED BEST PRACTICES.

5. QUANTITIES

A. FOR ALL SPECIFICATIONS THAT CONTAIN MORE OR LESS QUANTITIES, IT SHALL BE UNDERSTOOD AND AGREED THAT QUANTITIES LISTED IN THE SPECIFICATIONS ARE ESTIMATED ONLY AND MAY BE INCREASED OR DECREASED IN ACCORDANCE WITH THE REQUIREMENTS OF THE OWNER.

6. PUMP TRACK 70/30 CLAY MIX SURFACE MATERIAL

A. THE INTENT OF THE PUMP TRACK 70/30 CLAY MIX SURFACE MATERIAL IS TO COVER THE EXISTING SOILS WITH A WELL-BALANCED SURFACE THAT FACILITATES DRAINAGE, COMPACTS WELL, AND THAT PERFORMS REASONABLY IN BOTH WET AND DRY WEATHER CONDITIONS. PUMP TRACK 70/30 CLAY MIX SURFACE MATERIAL SHALL BE INCIDENTAL TO THE UNIT RATE FOR PUMP TRACK CONSTRUCTION. DESIRED CHARACTERISTICS INCLUDE:

-DRAINS WELL AND FACILITATES SHEET DRAINAGE

Consultant

- STAYS FIRM AND COHESIVE WHEN MOIST
- STAYS FIRM AND COHESIVE WHEN DRY
- RESISTS SHEER FORCES CREATED BY BICYCLE TIRES (CORNERING, BRAKING, AND ACCELERATING)

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2018.09.06

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- REASONABLY PLIABLE IN ORDER TO SHAPE TRACK SURFACE AND PERFORM MAINTENANCE

B. THE 70/30 CLAY MIX SURFACE MATERIAL MUST BE DEMONSTRATED AND TESTED IN BOTH WET AND DRY CONDITIONS ON THE SAMPLE TRAIL SECTIONS DESCRIBED IN THE PUMP TRACK ASPHALT TECHNICAL SPECIFICATIONS AND/OR AS DIRECTED BY PUMP TRACK DESIGNER/OWNER'S REPRESENTATIVE. MODIFICATIONS TO THE MATERIAL MAY BE NECESSARY BASED ON THE SAMPLE TEST. OWNER'S REPRESENTATIVE MUST APPROVE THE MATERIAL BEFORE ADDITIONAL CONSTRUCTION MAY PROCEED.

C. APPLY SOILTAC ADDITIVE PER MANUFACTURER'S RECOMMENDATIONS ON ALL SOIL

7. PREQUALIFICATIONS STATEMENT

RIDING SURFACES

A. THE CONTRACTOR SHALL HAVE BUILT A MINIMUM OF THREE (3) PUMP TRACKS IN THE LAST FIVE (5) YEARS EQUAL IN SIZE AND COMPLEXITY TO ENSURE SUCCESSFUL PROJECT COMPLETION. CONTRACTOR SHALL PROVIDE PROOF OF PROFICIENCY, WITH REFERENCES. TO THE CITY AT TIME OF BID.

Davis

Client/Project Logo

CITY OF DAVIS

Client/Project

DAVIS COMMUNITY PARK PUMP TRACK

Davis, California

File Name: 222011228_0.0_PUMP TRACK NOTES JM/CL MM MM 2019.03.01

Dwn. Dsgn. Chkd. YYYY.MM.DD

Project No. Scale

222011228

Revision Sheet Drawing No.


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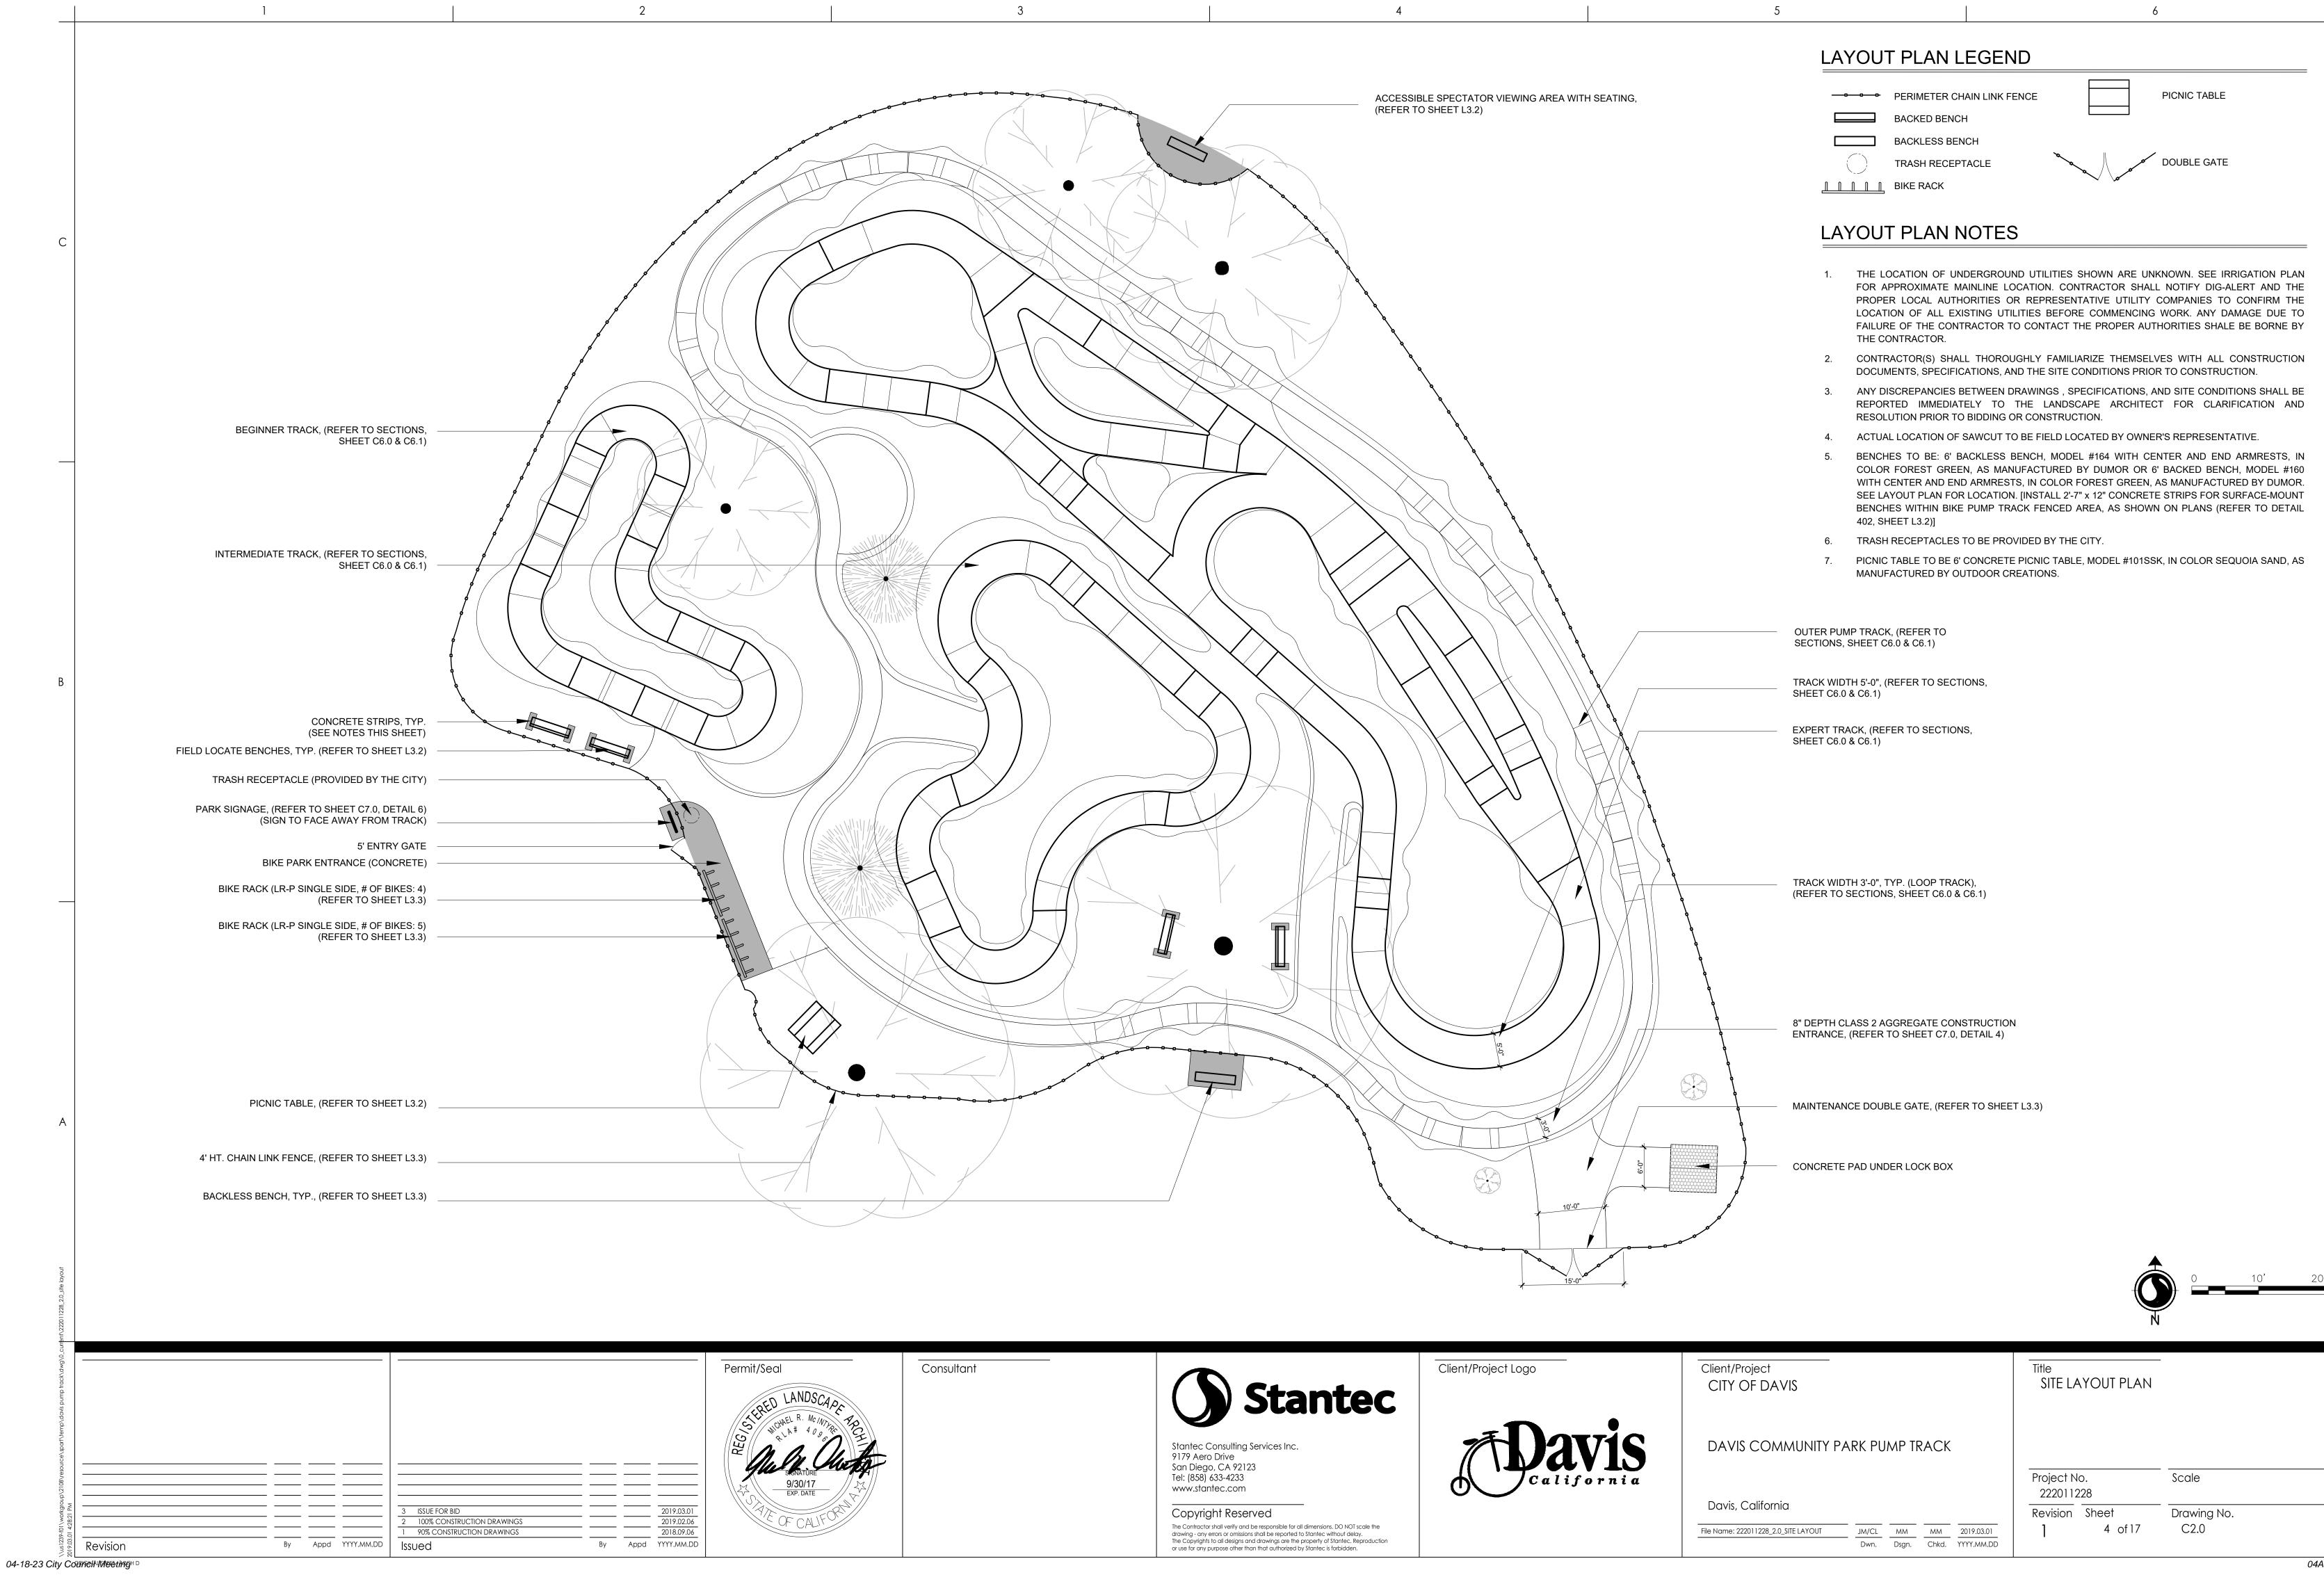
PUMP TRACK NOTES


Sea Revision


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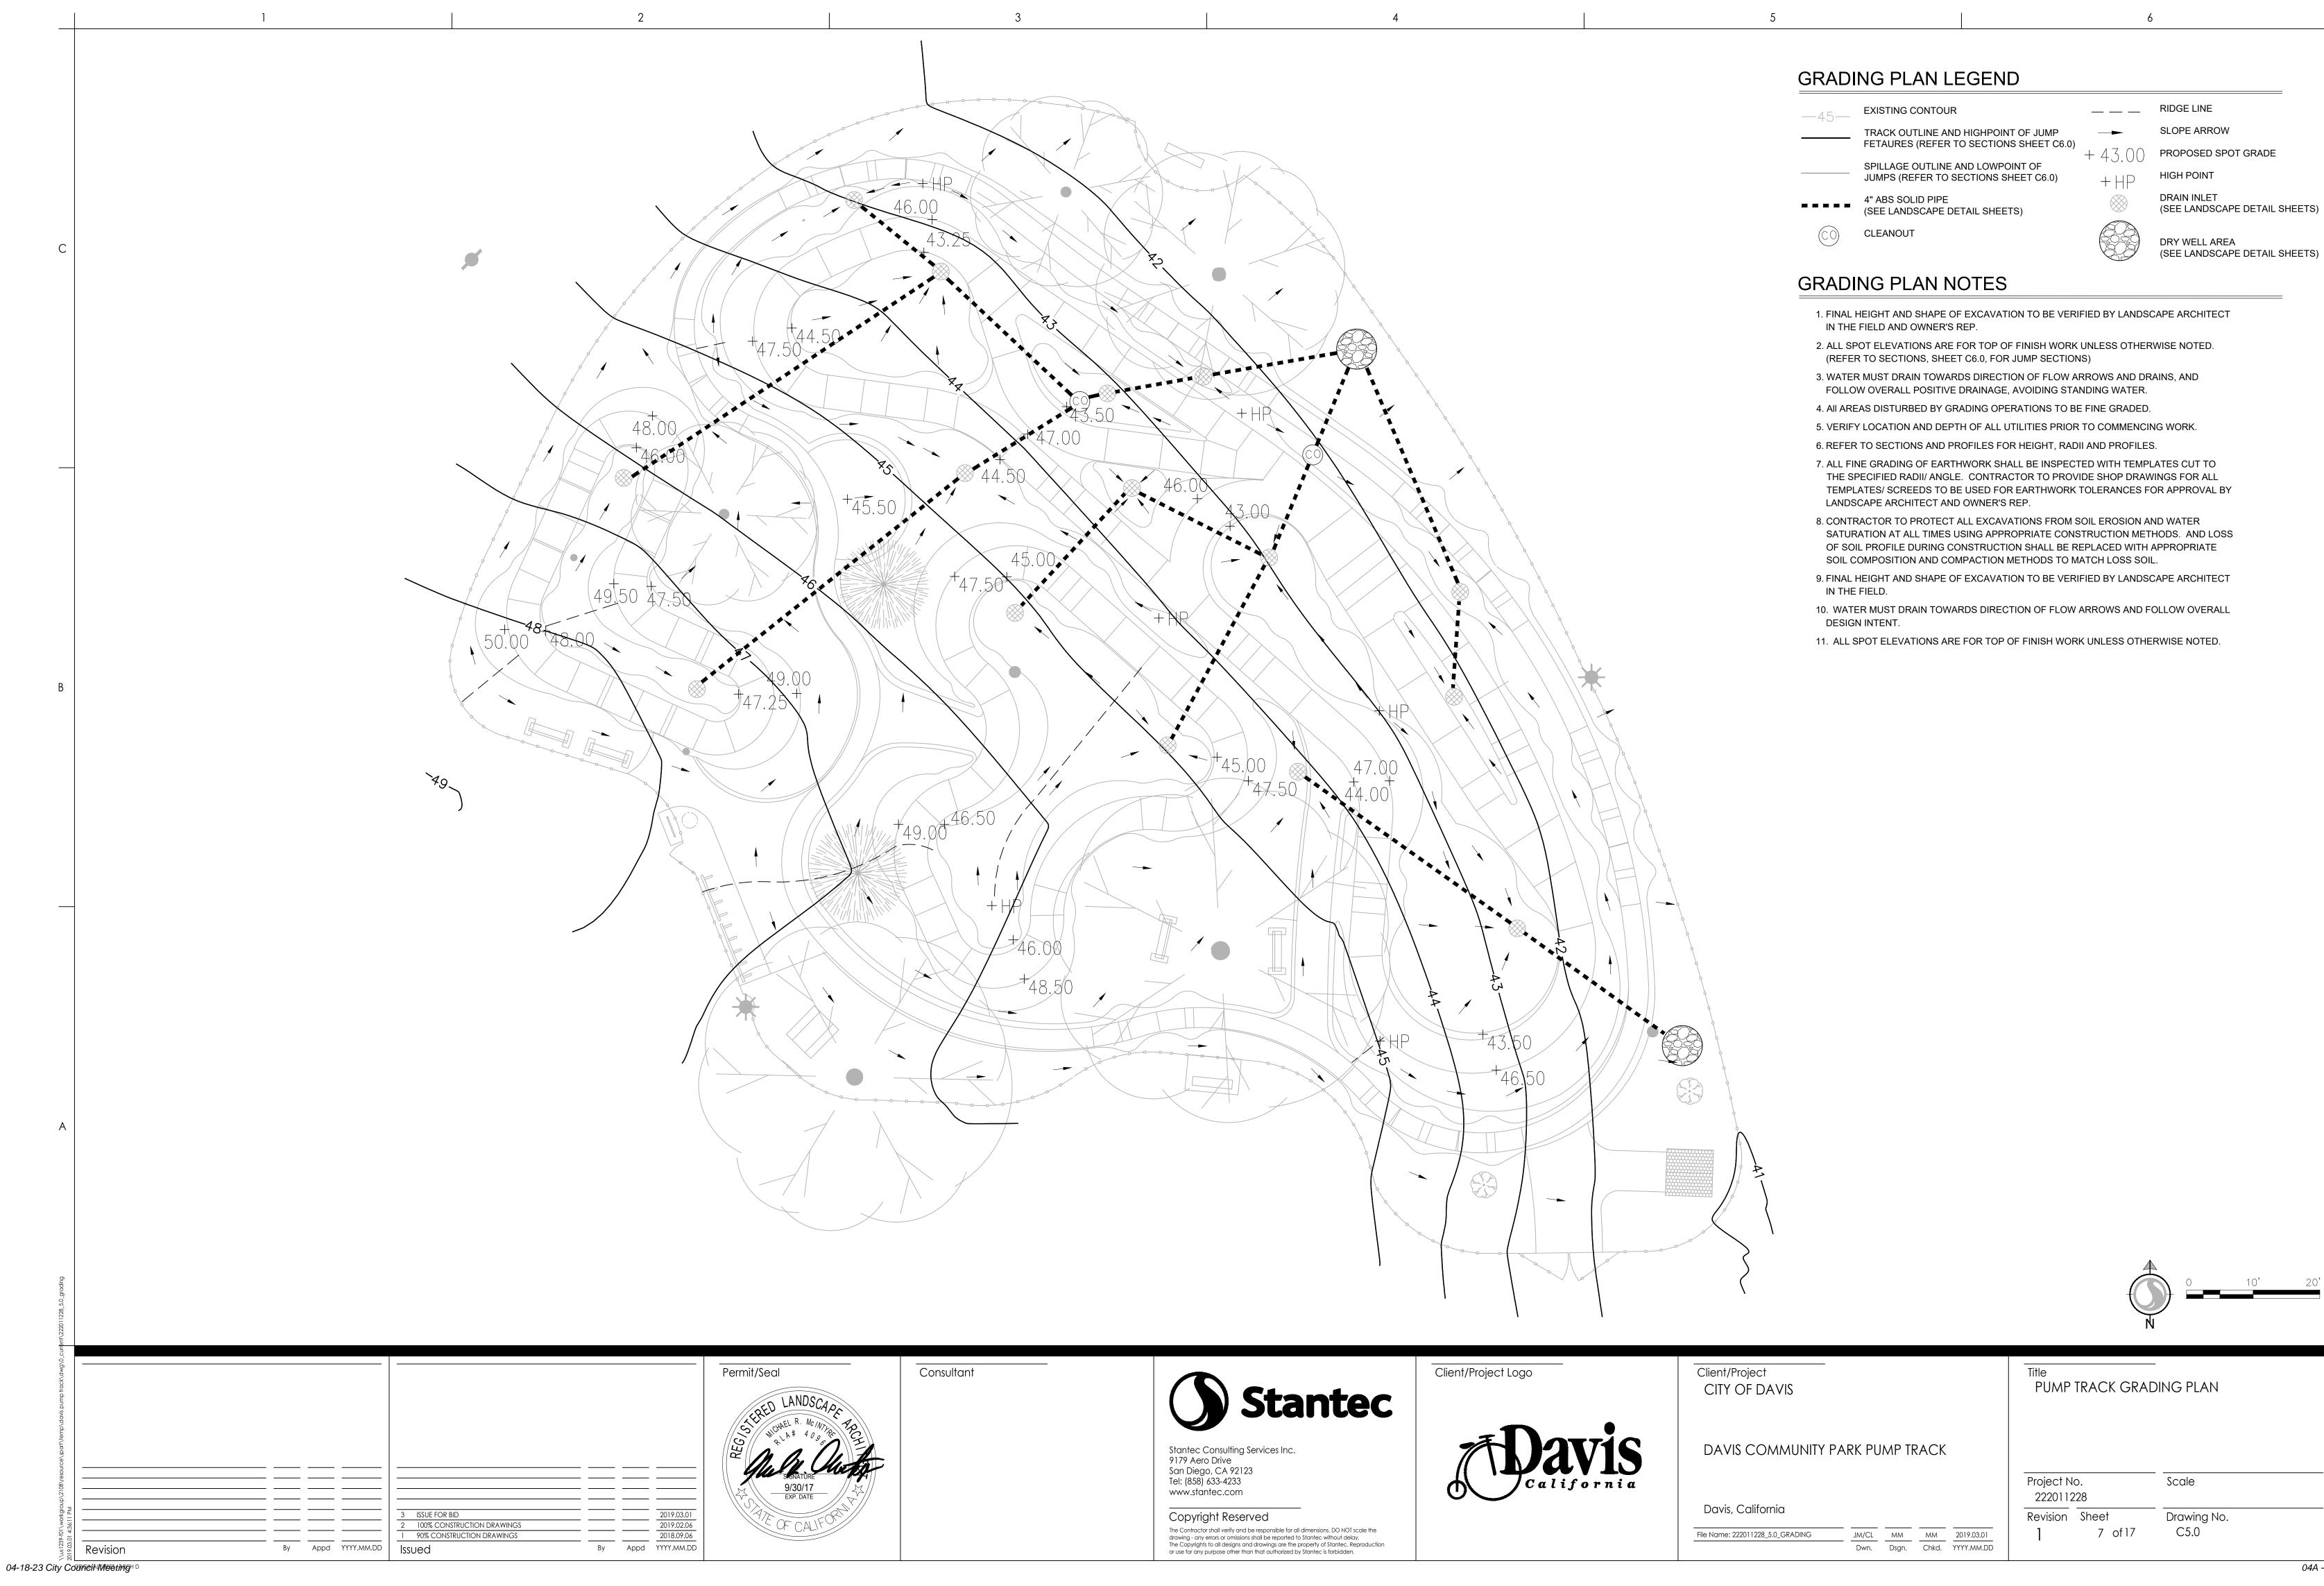
04A - 8







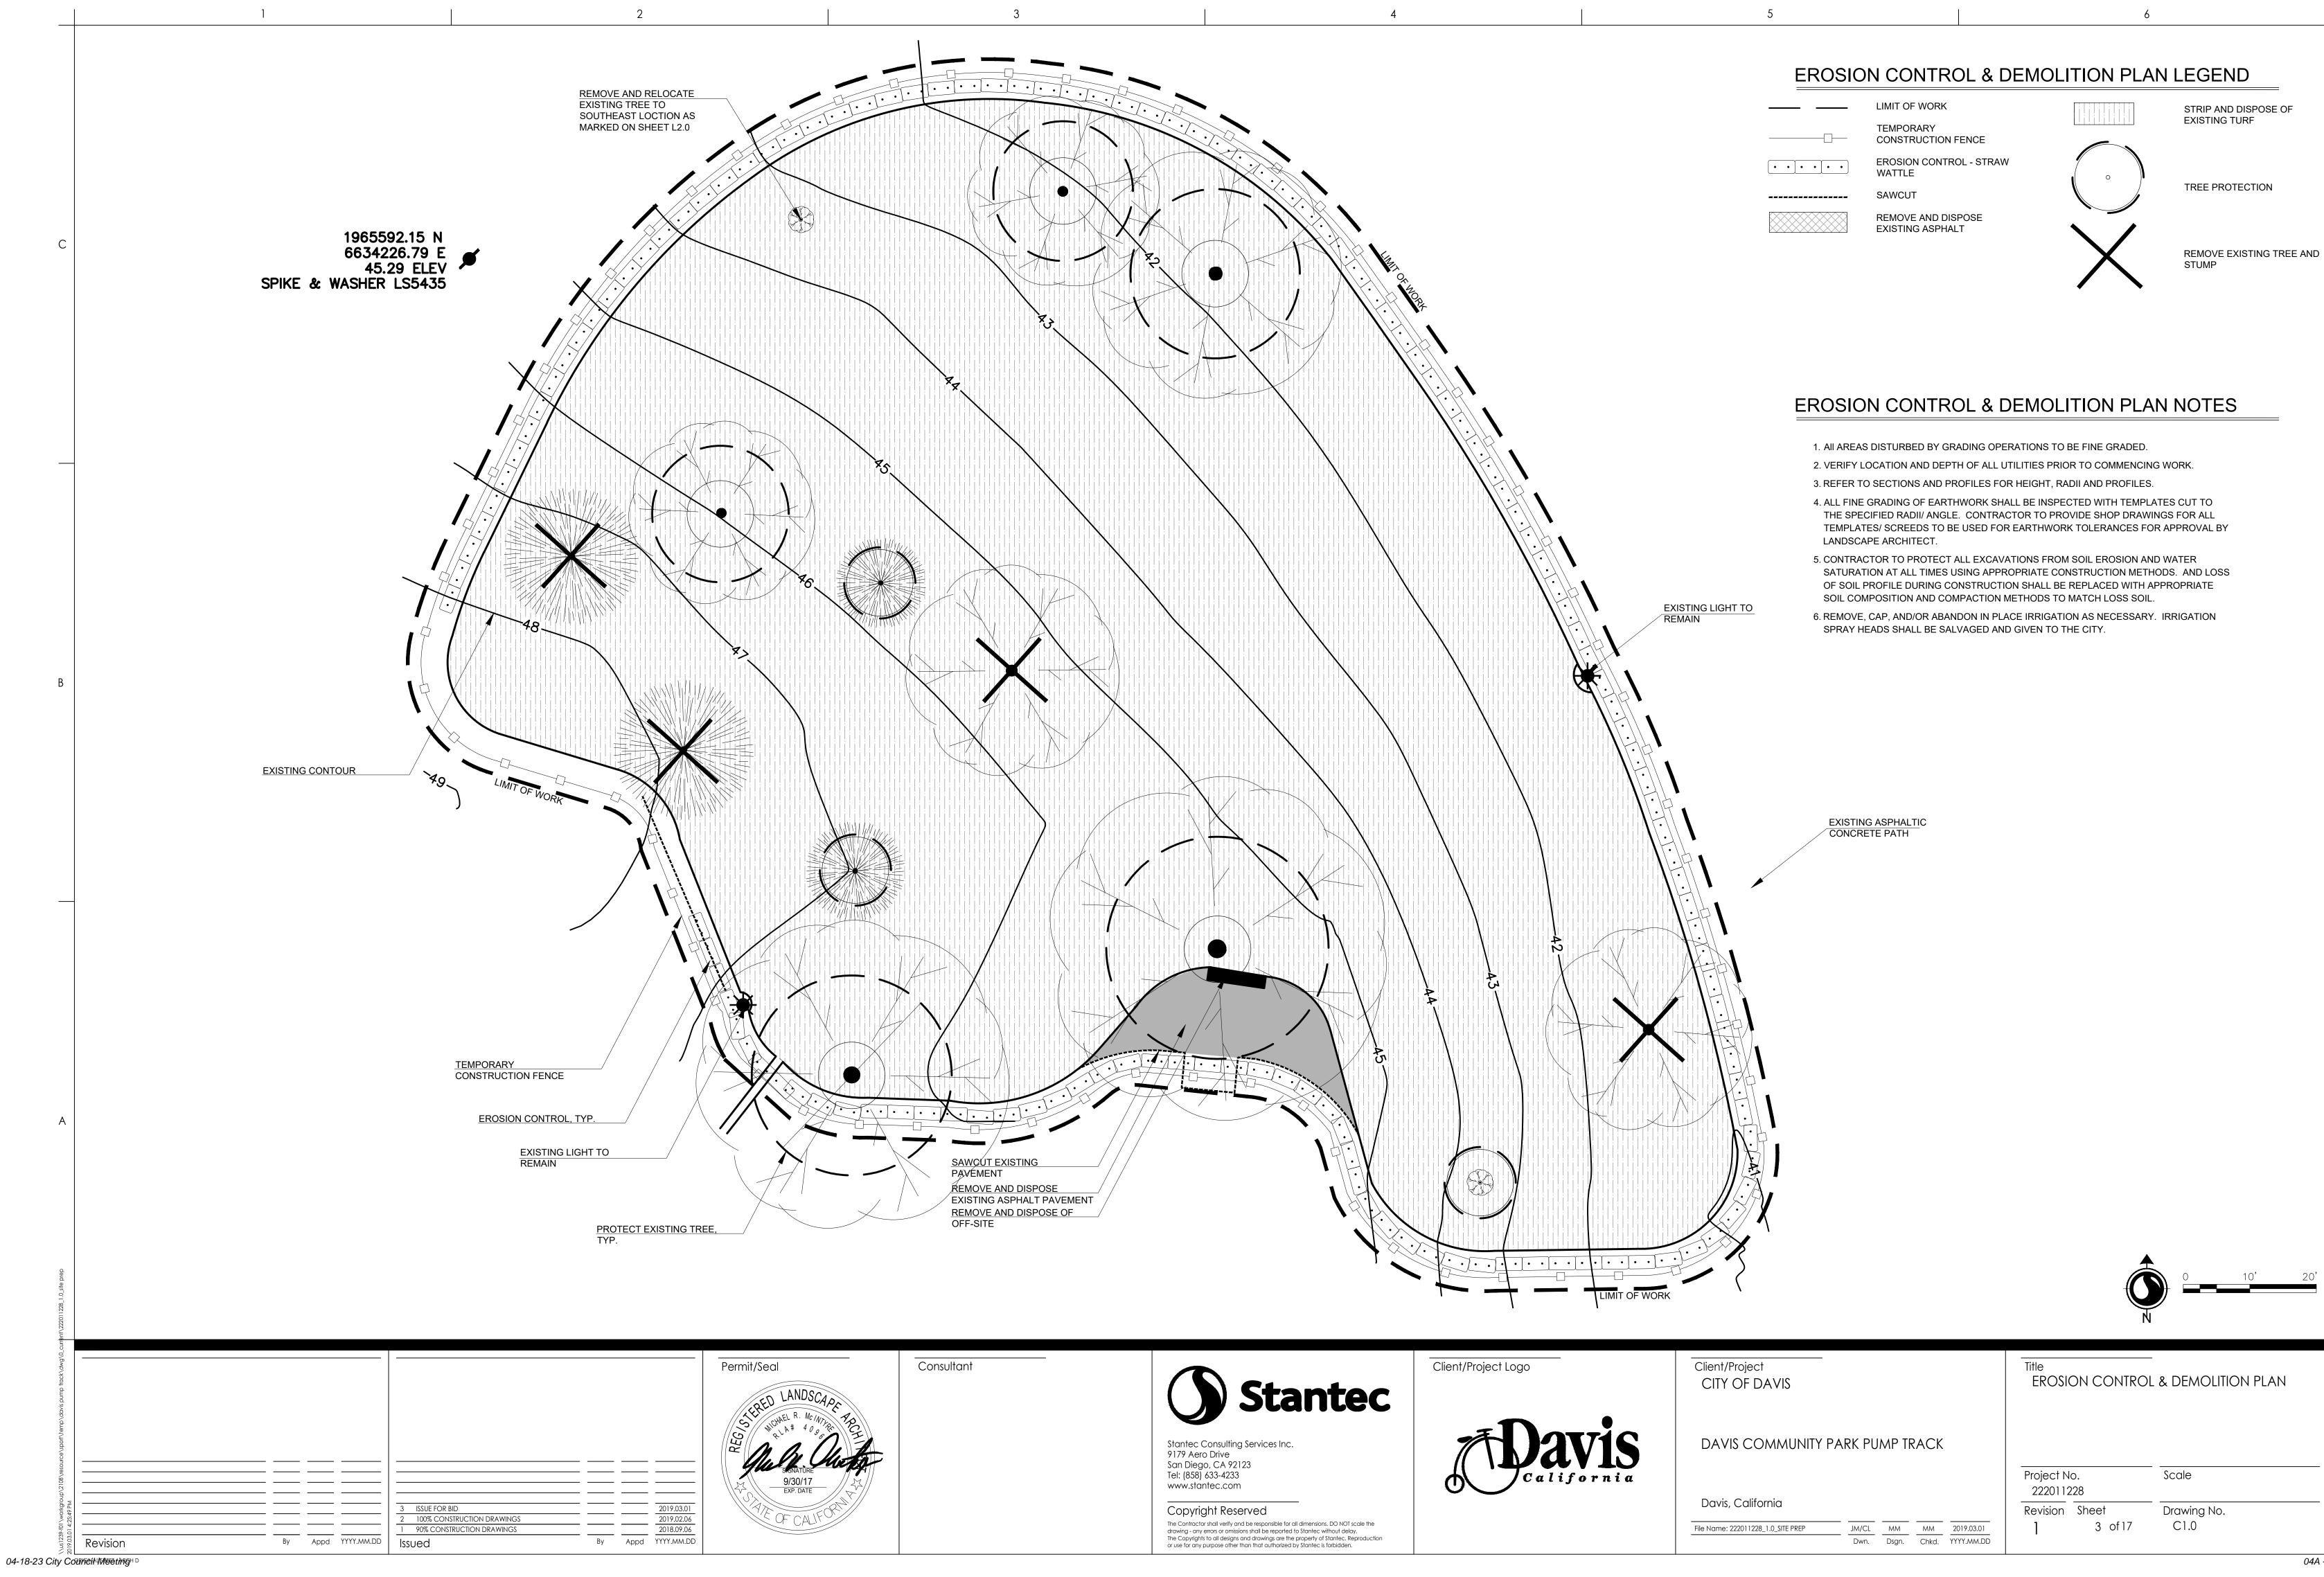


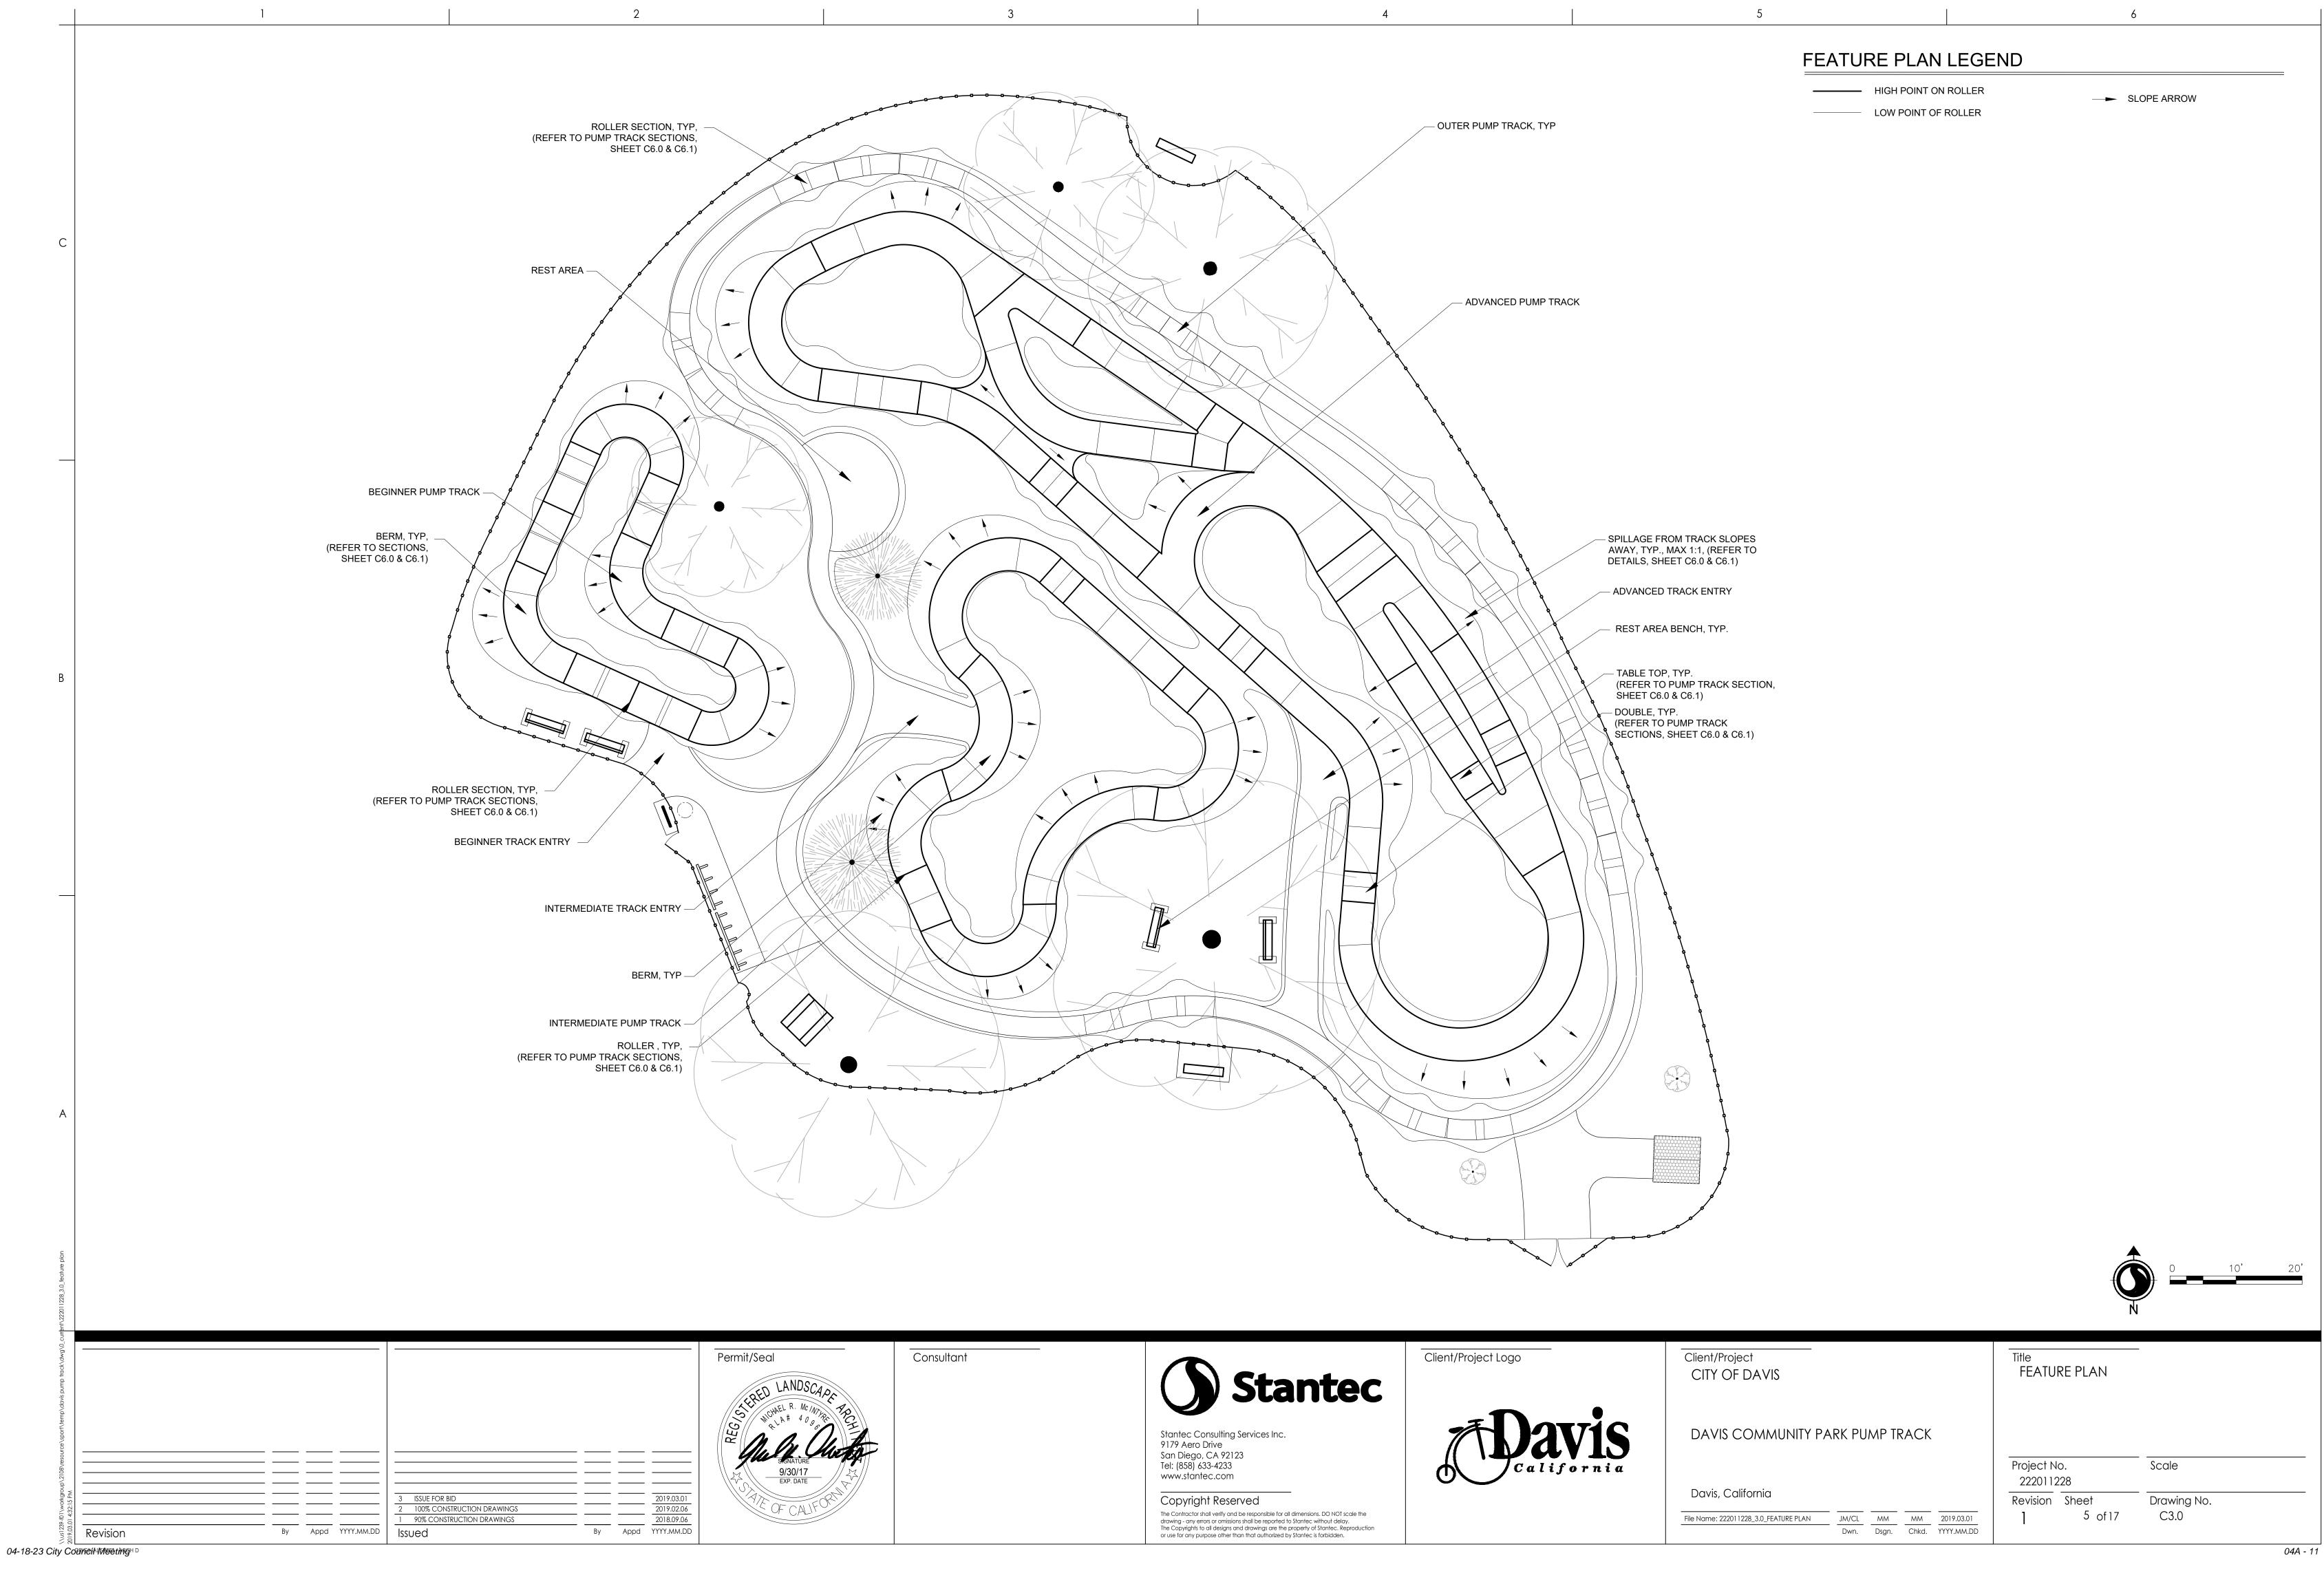

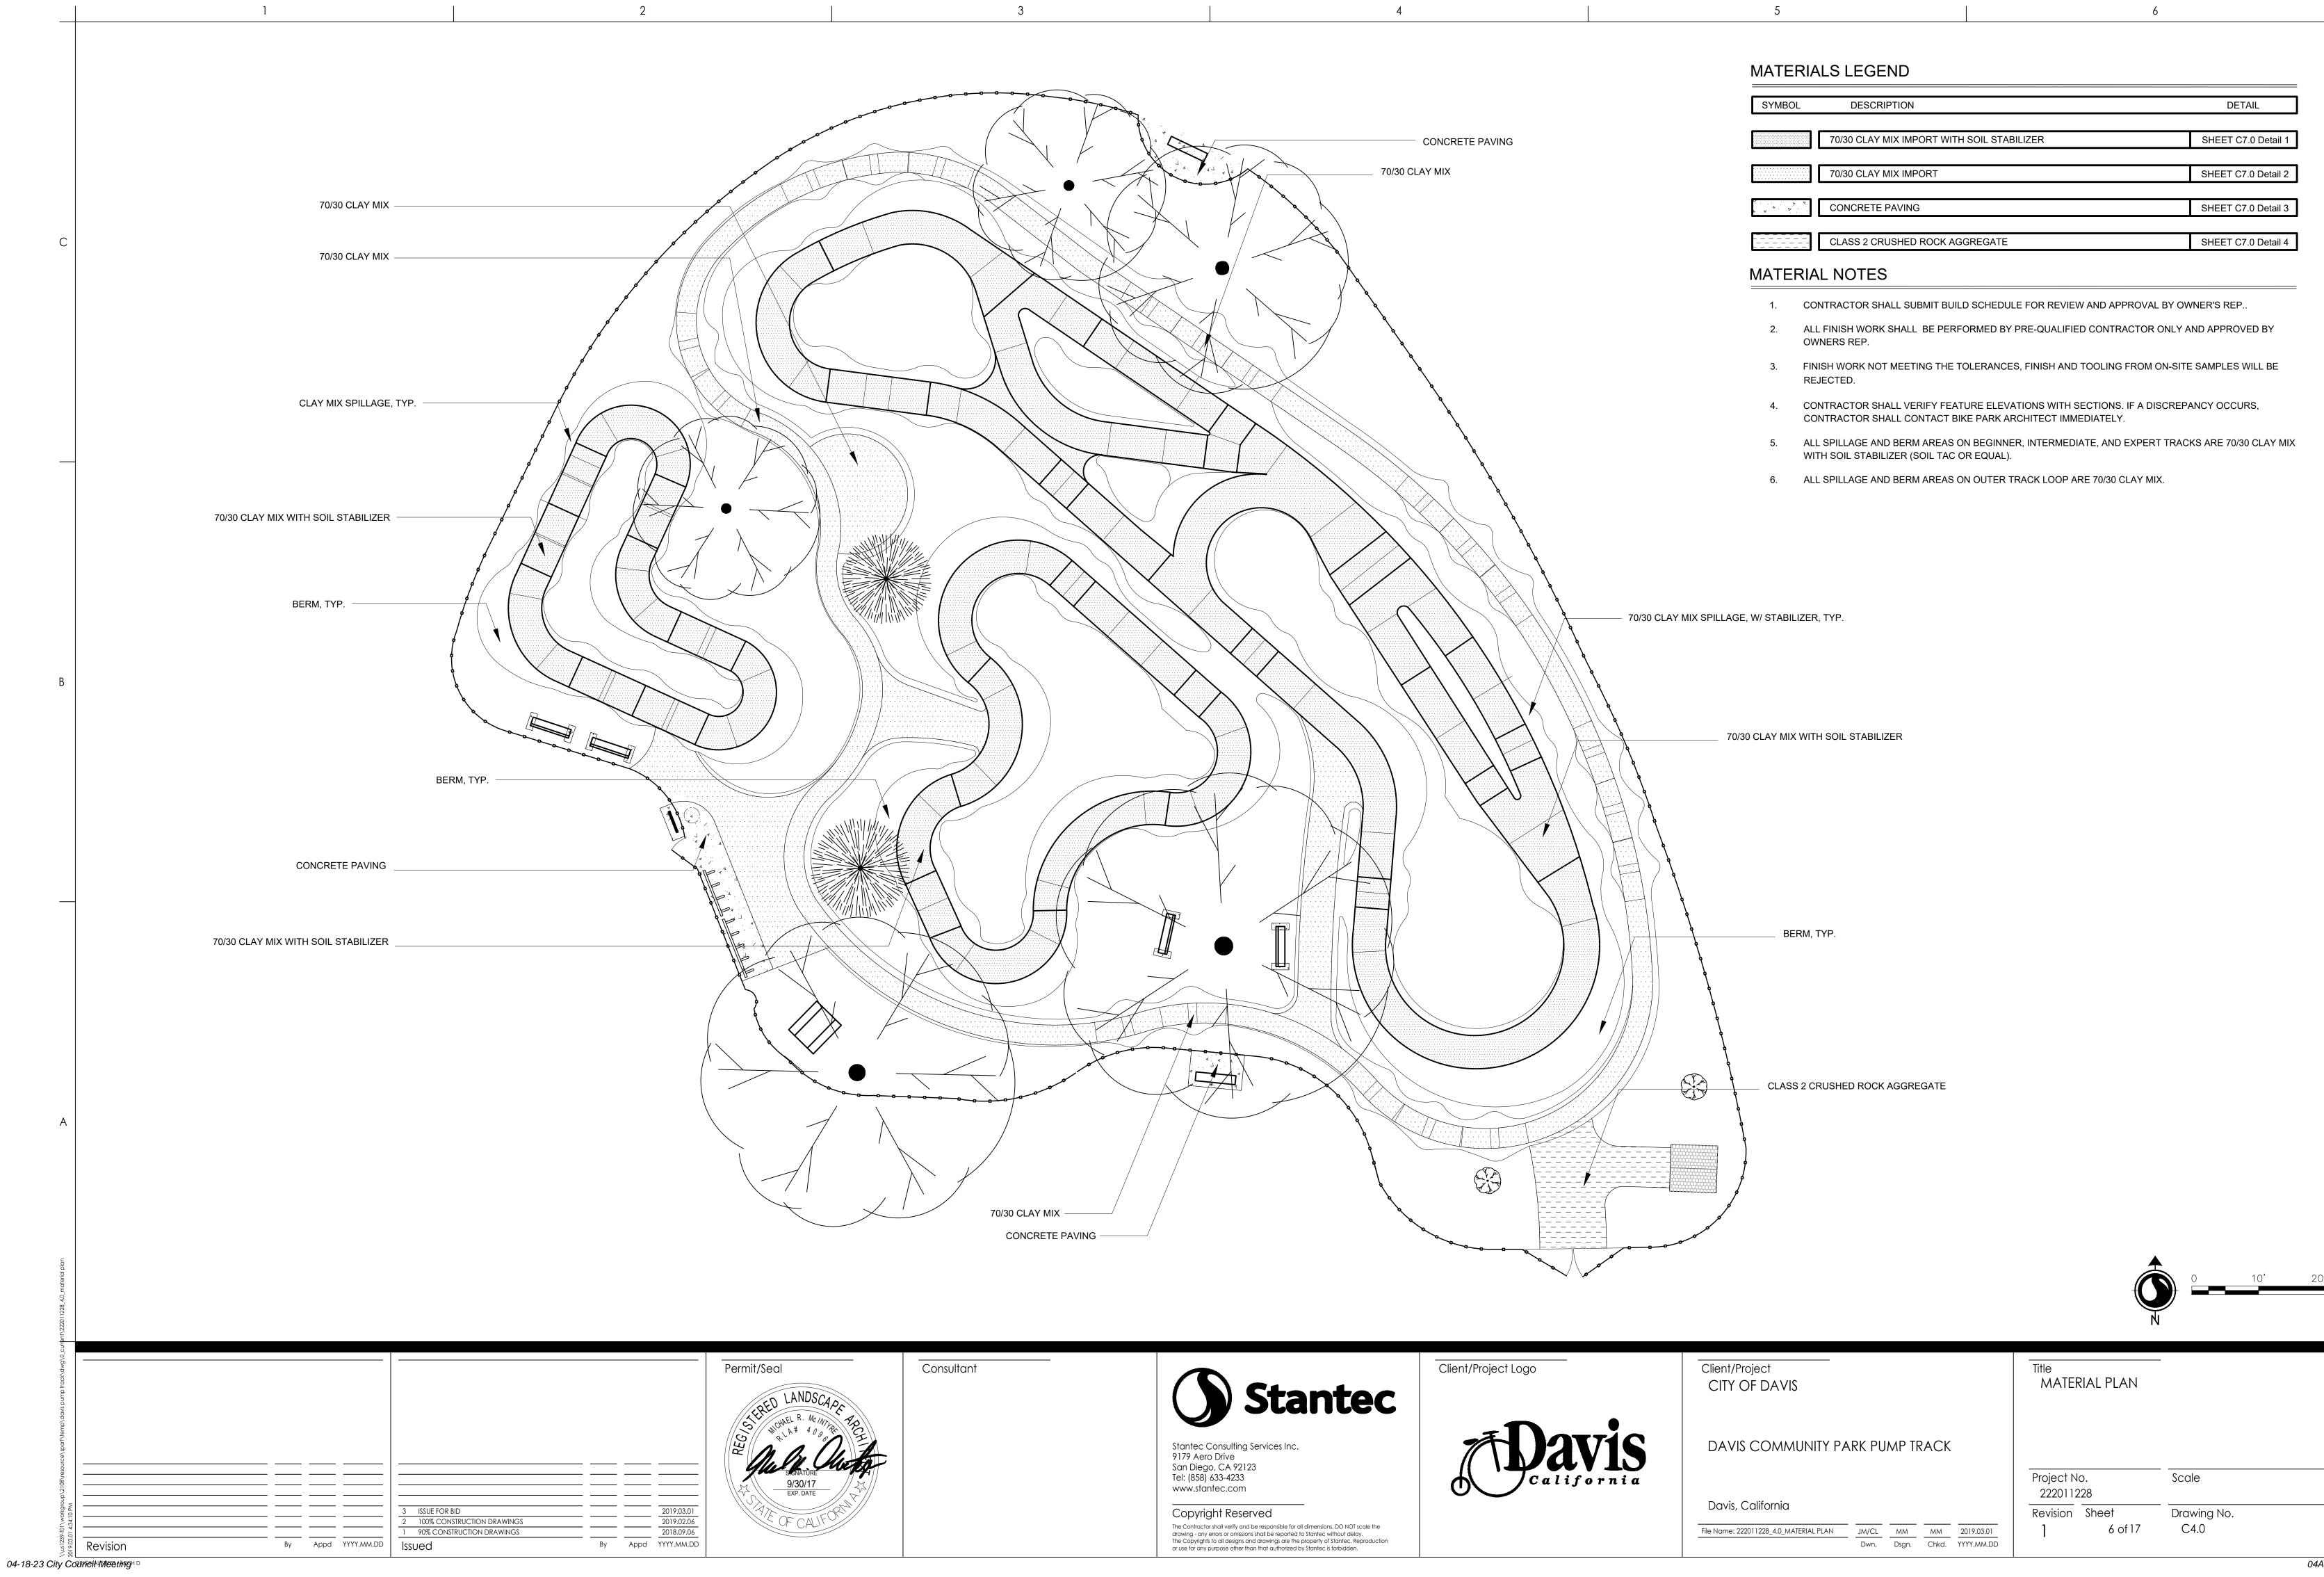

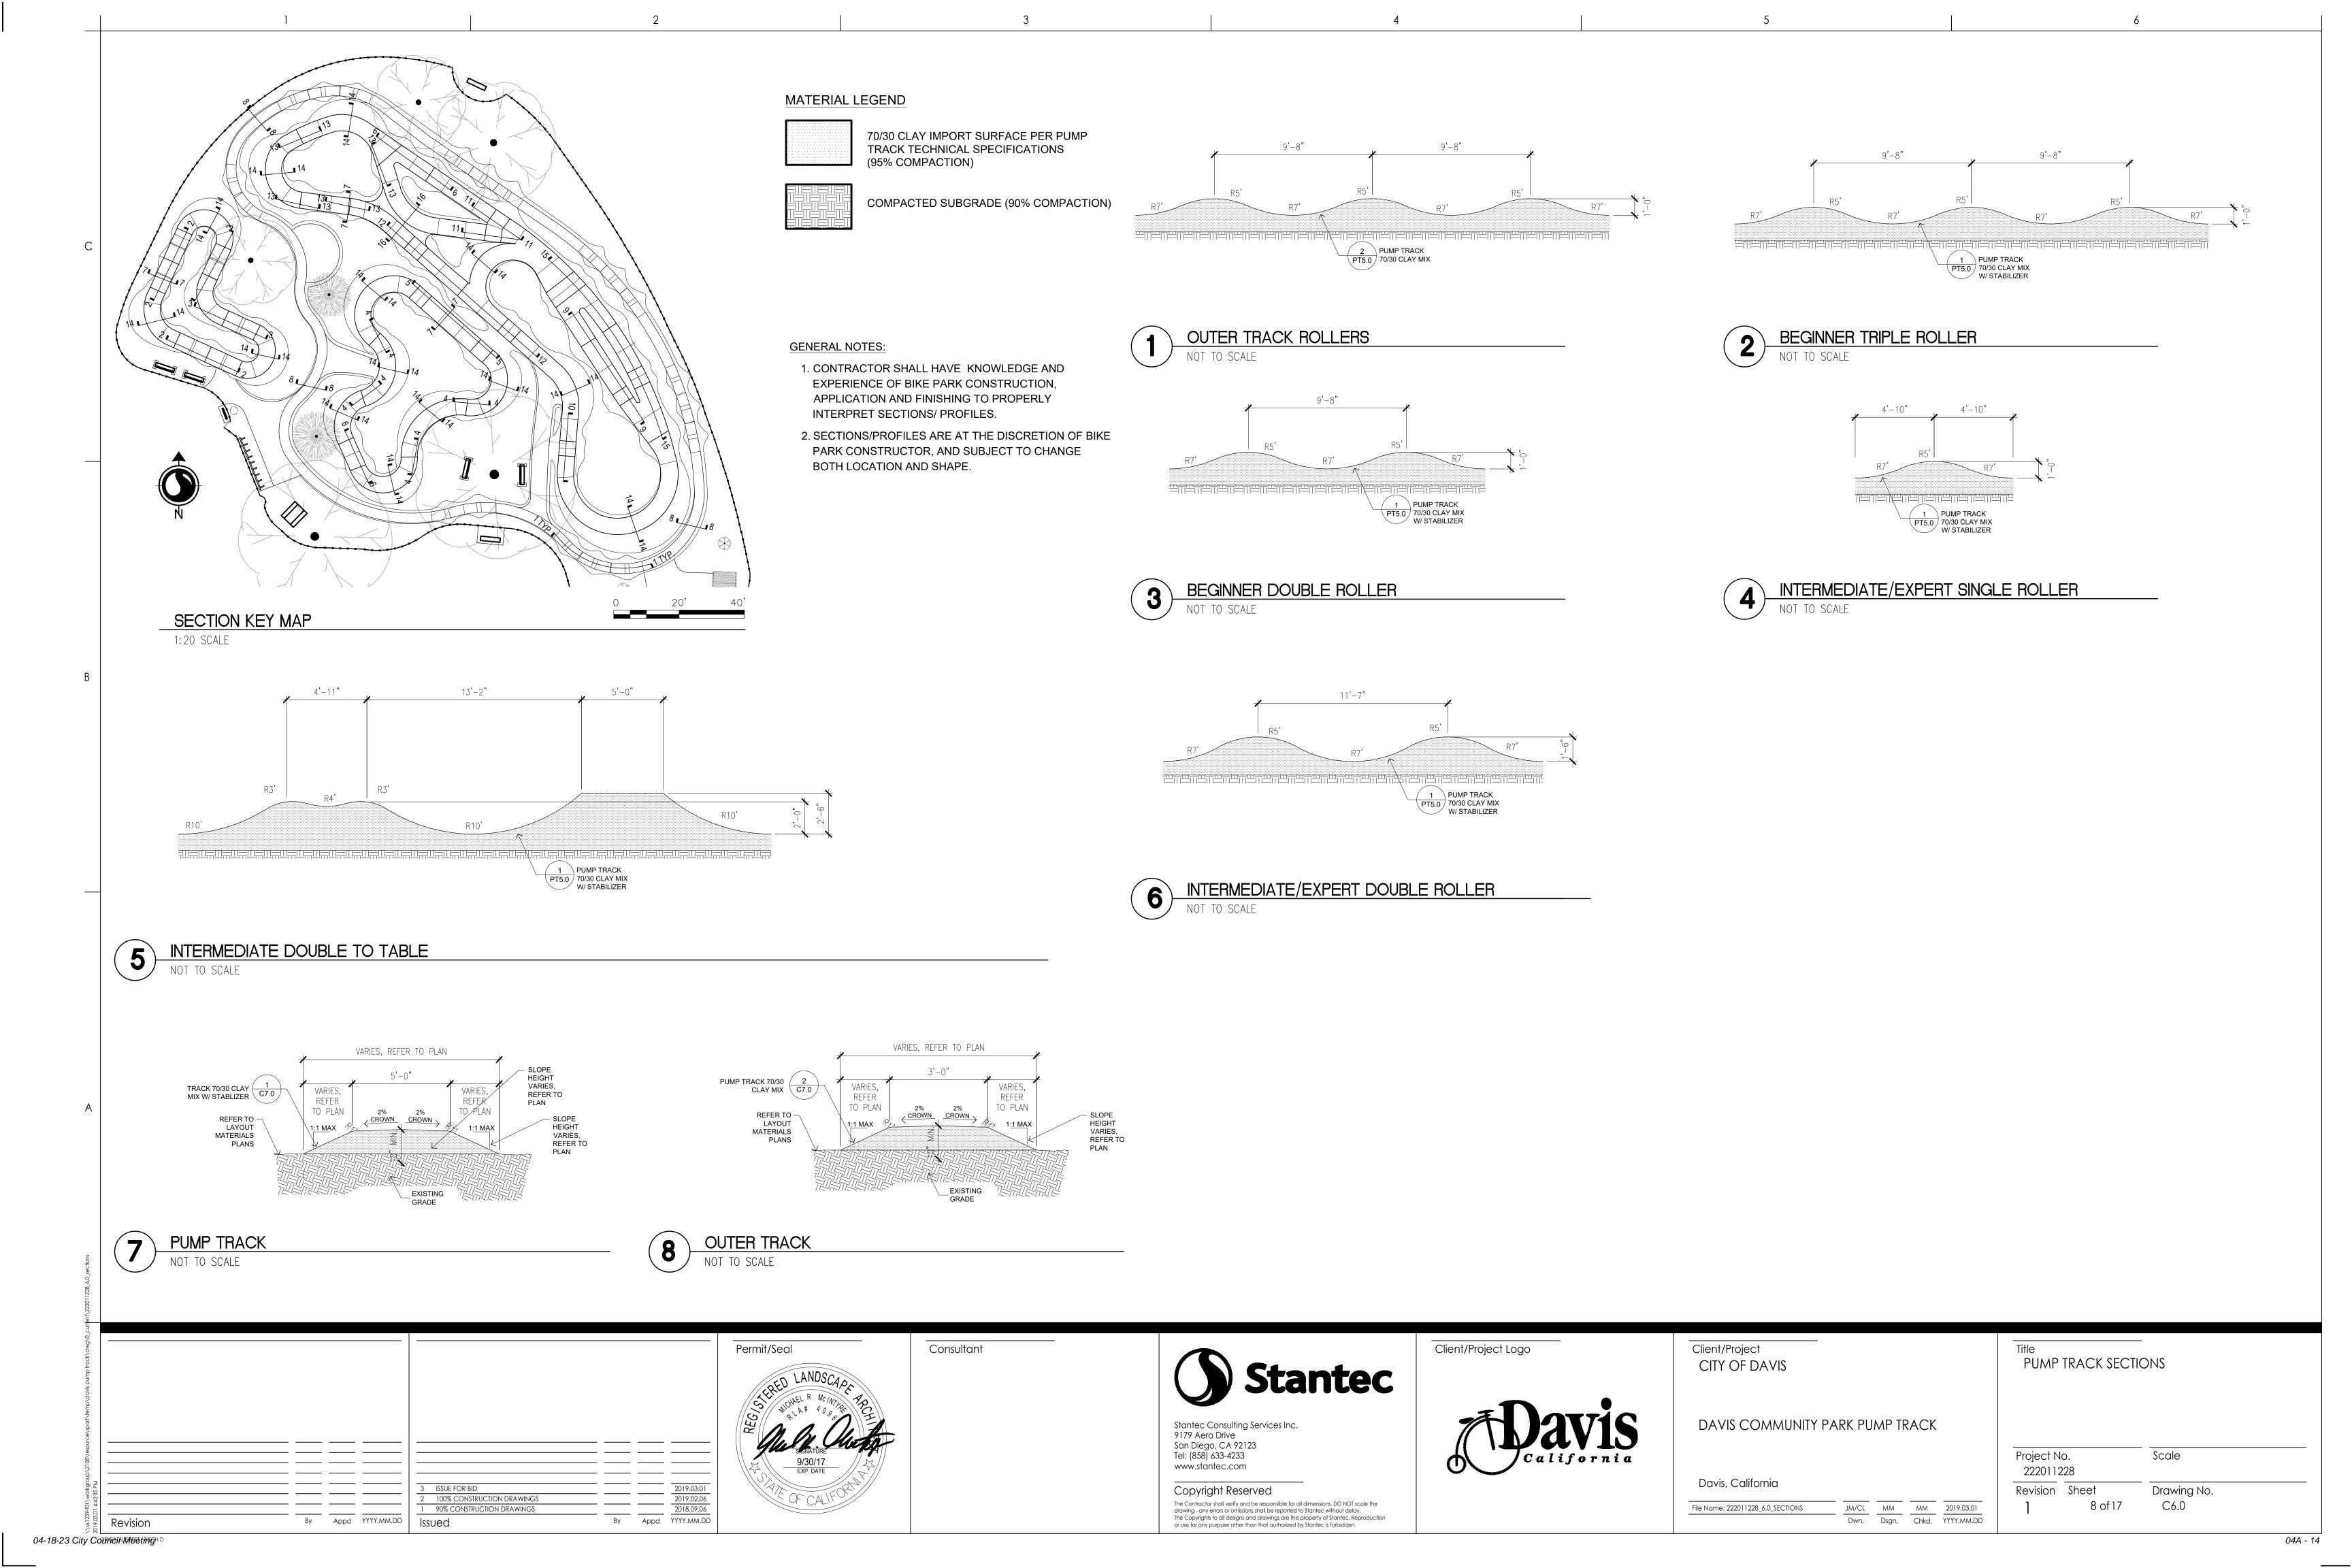

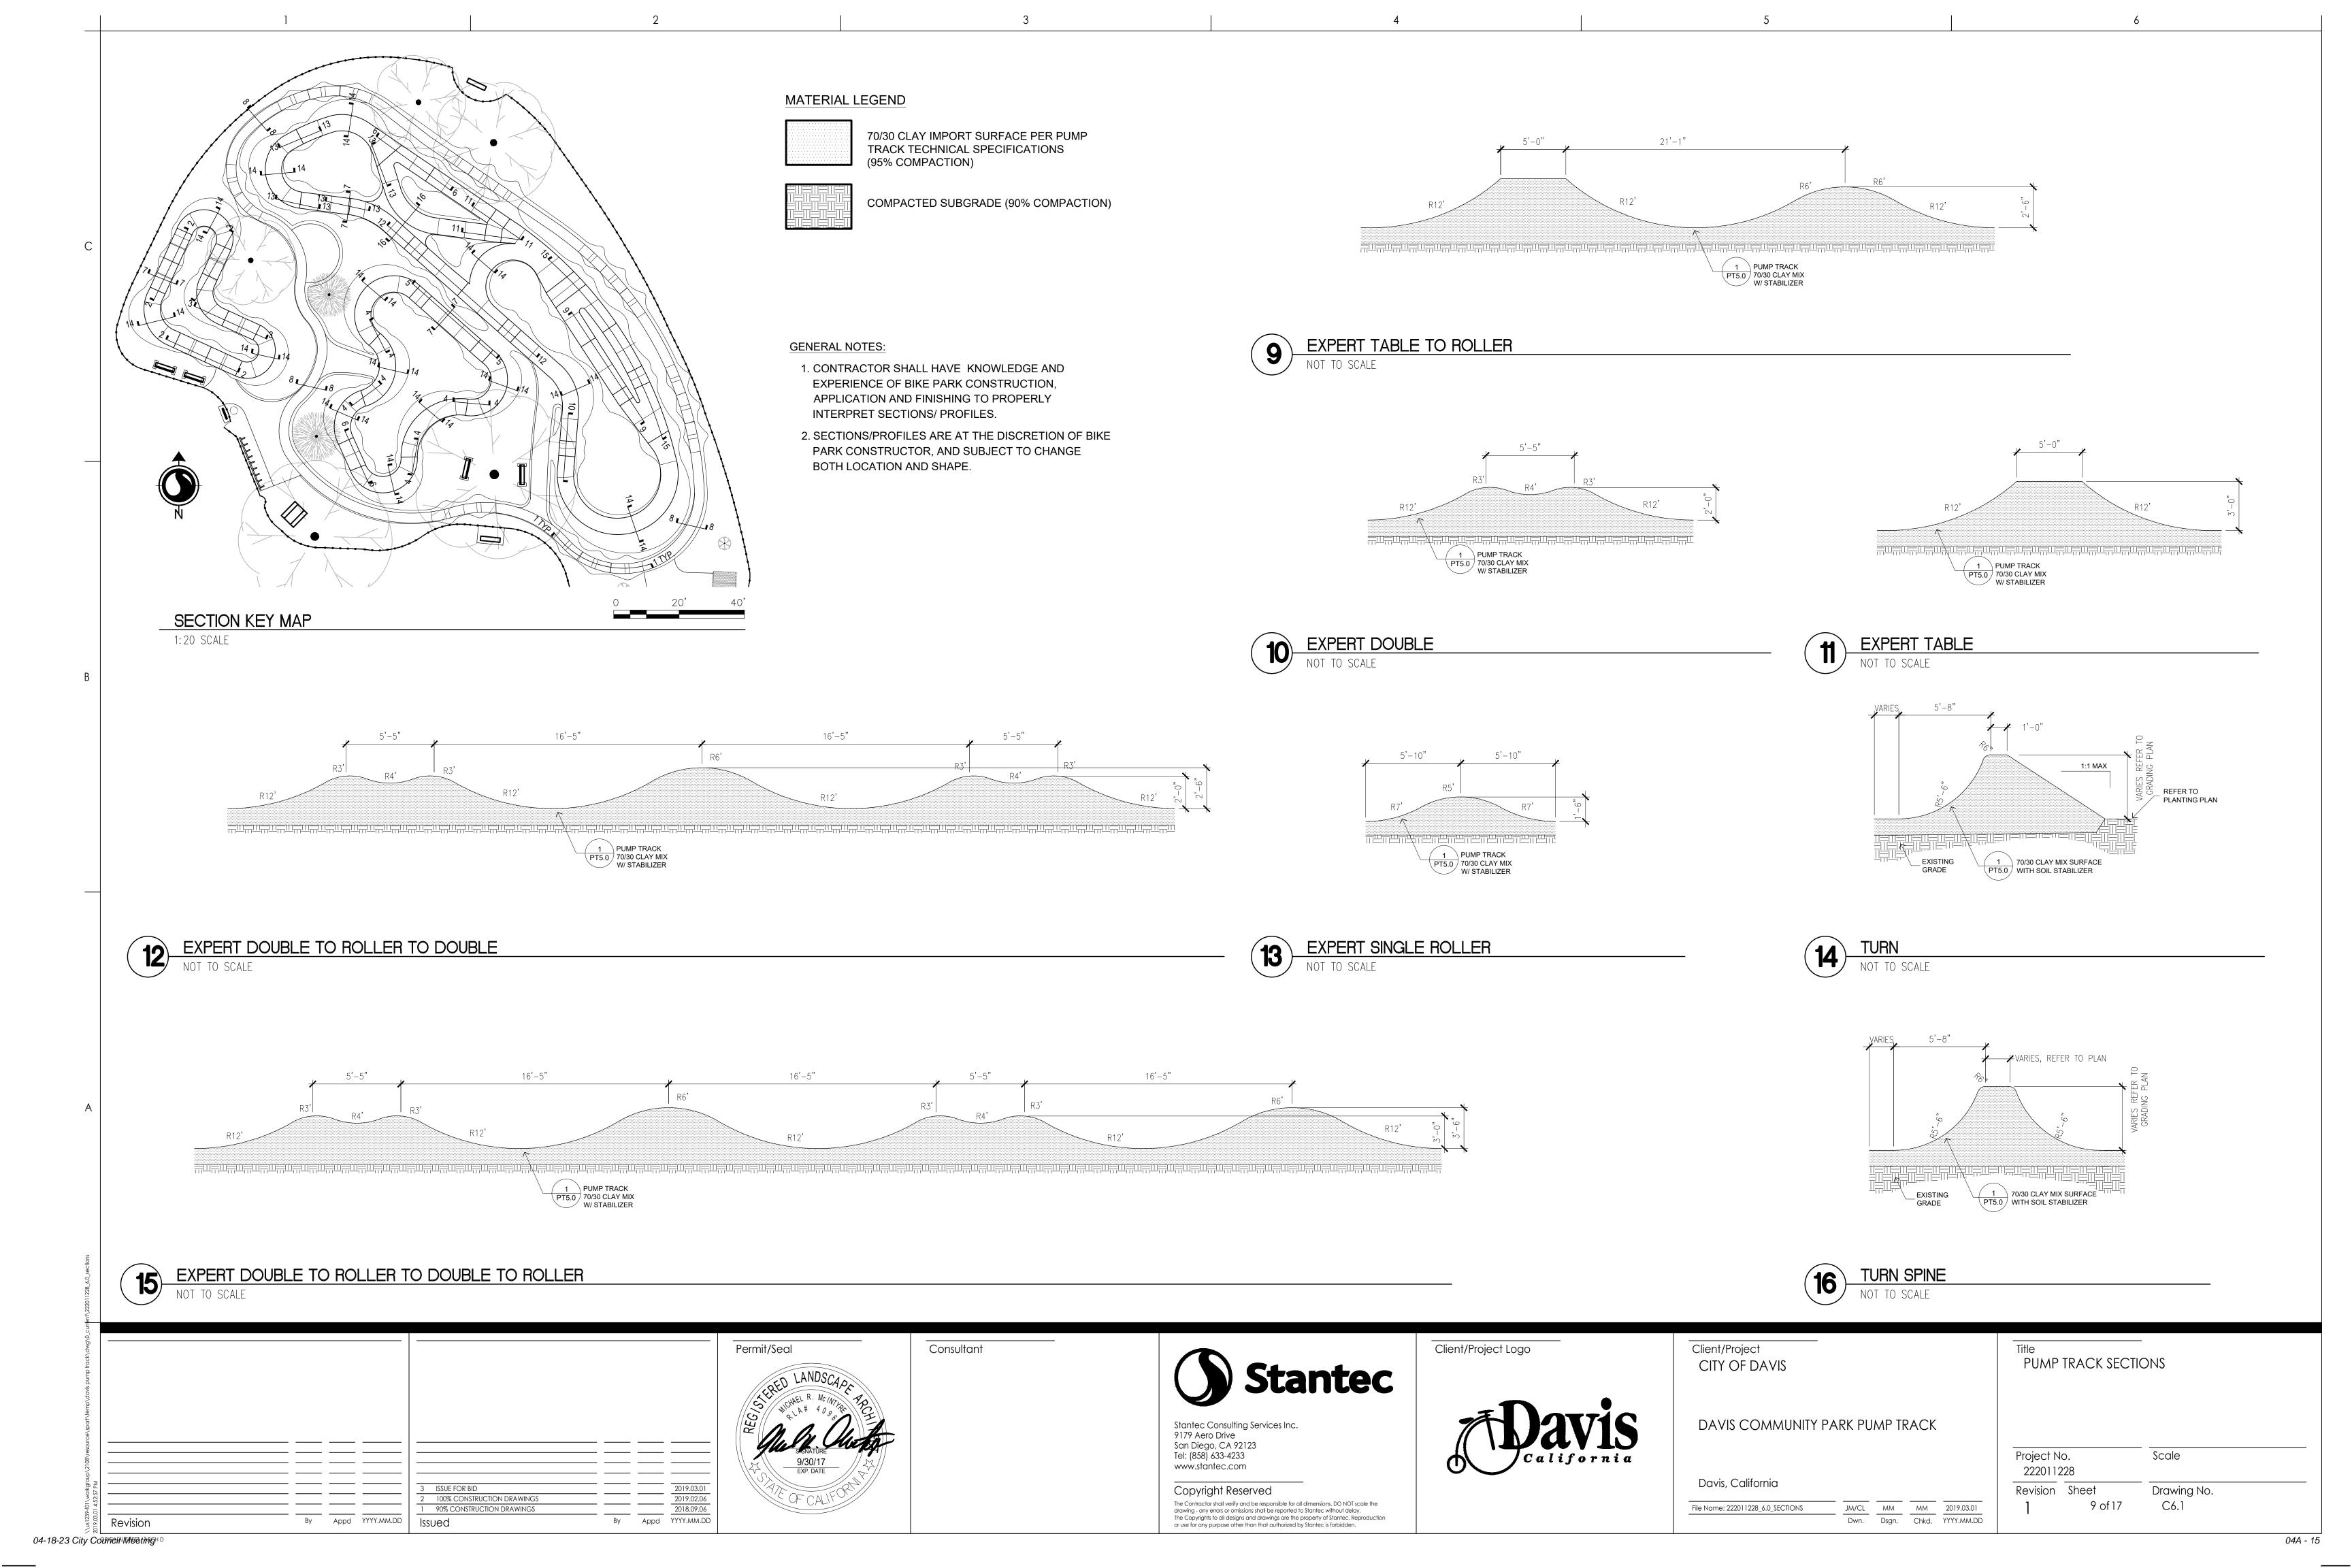

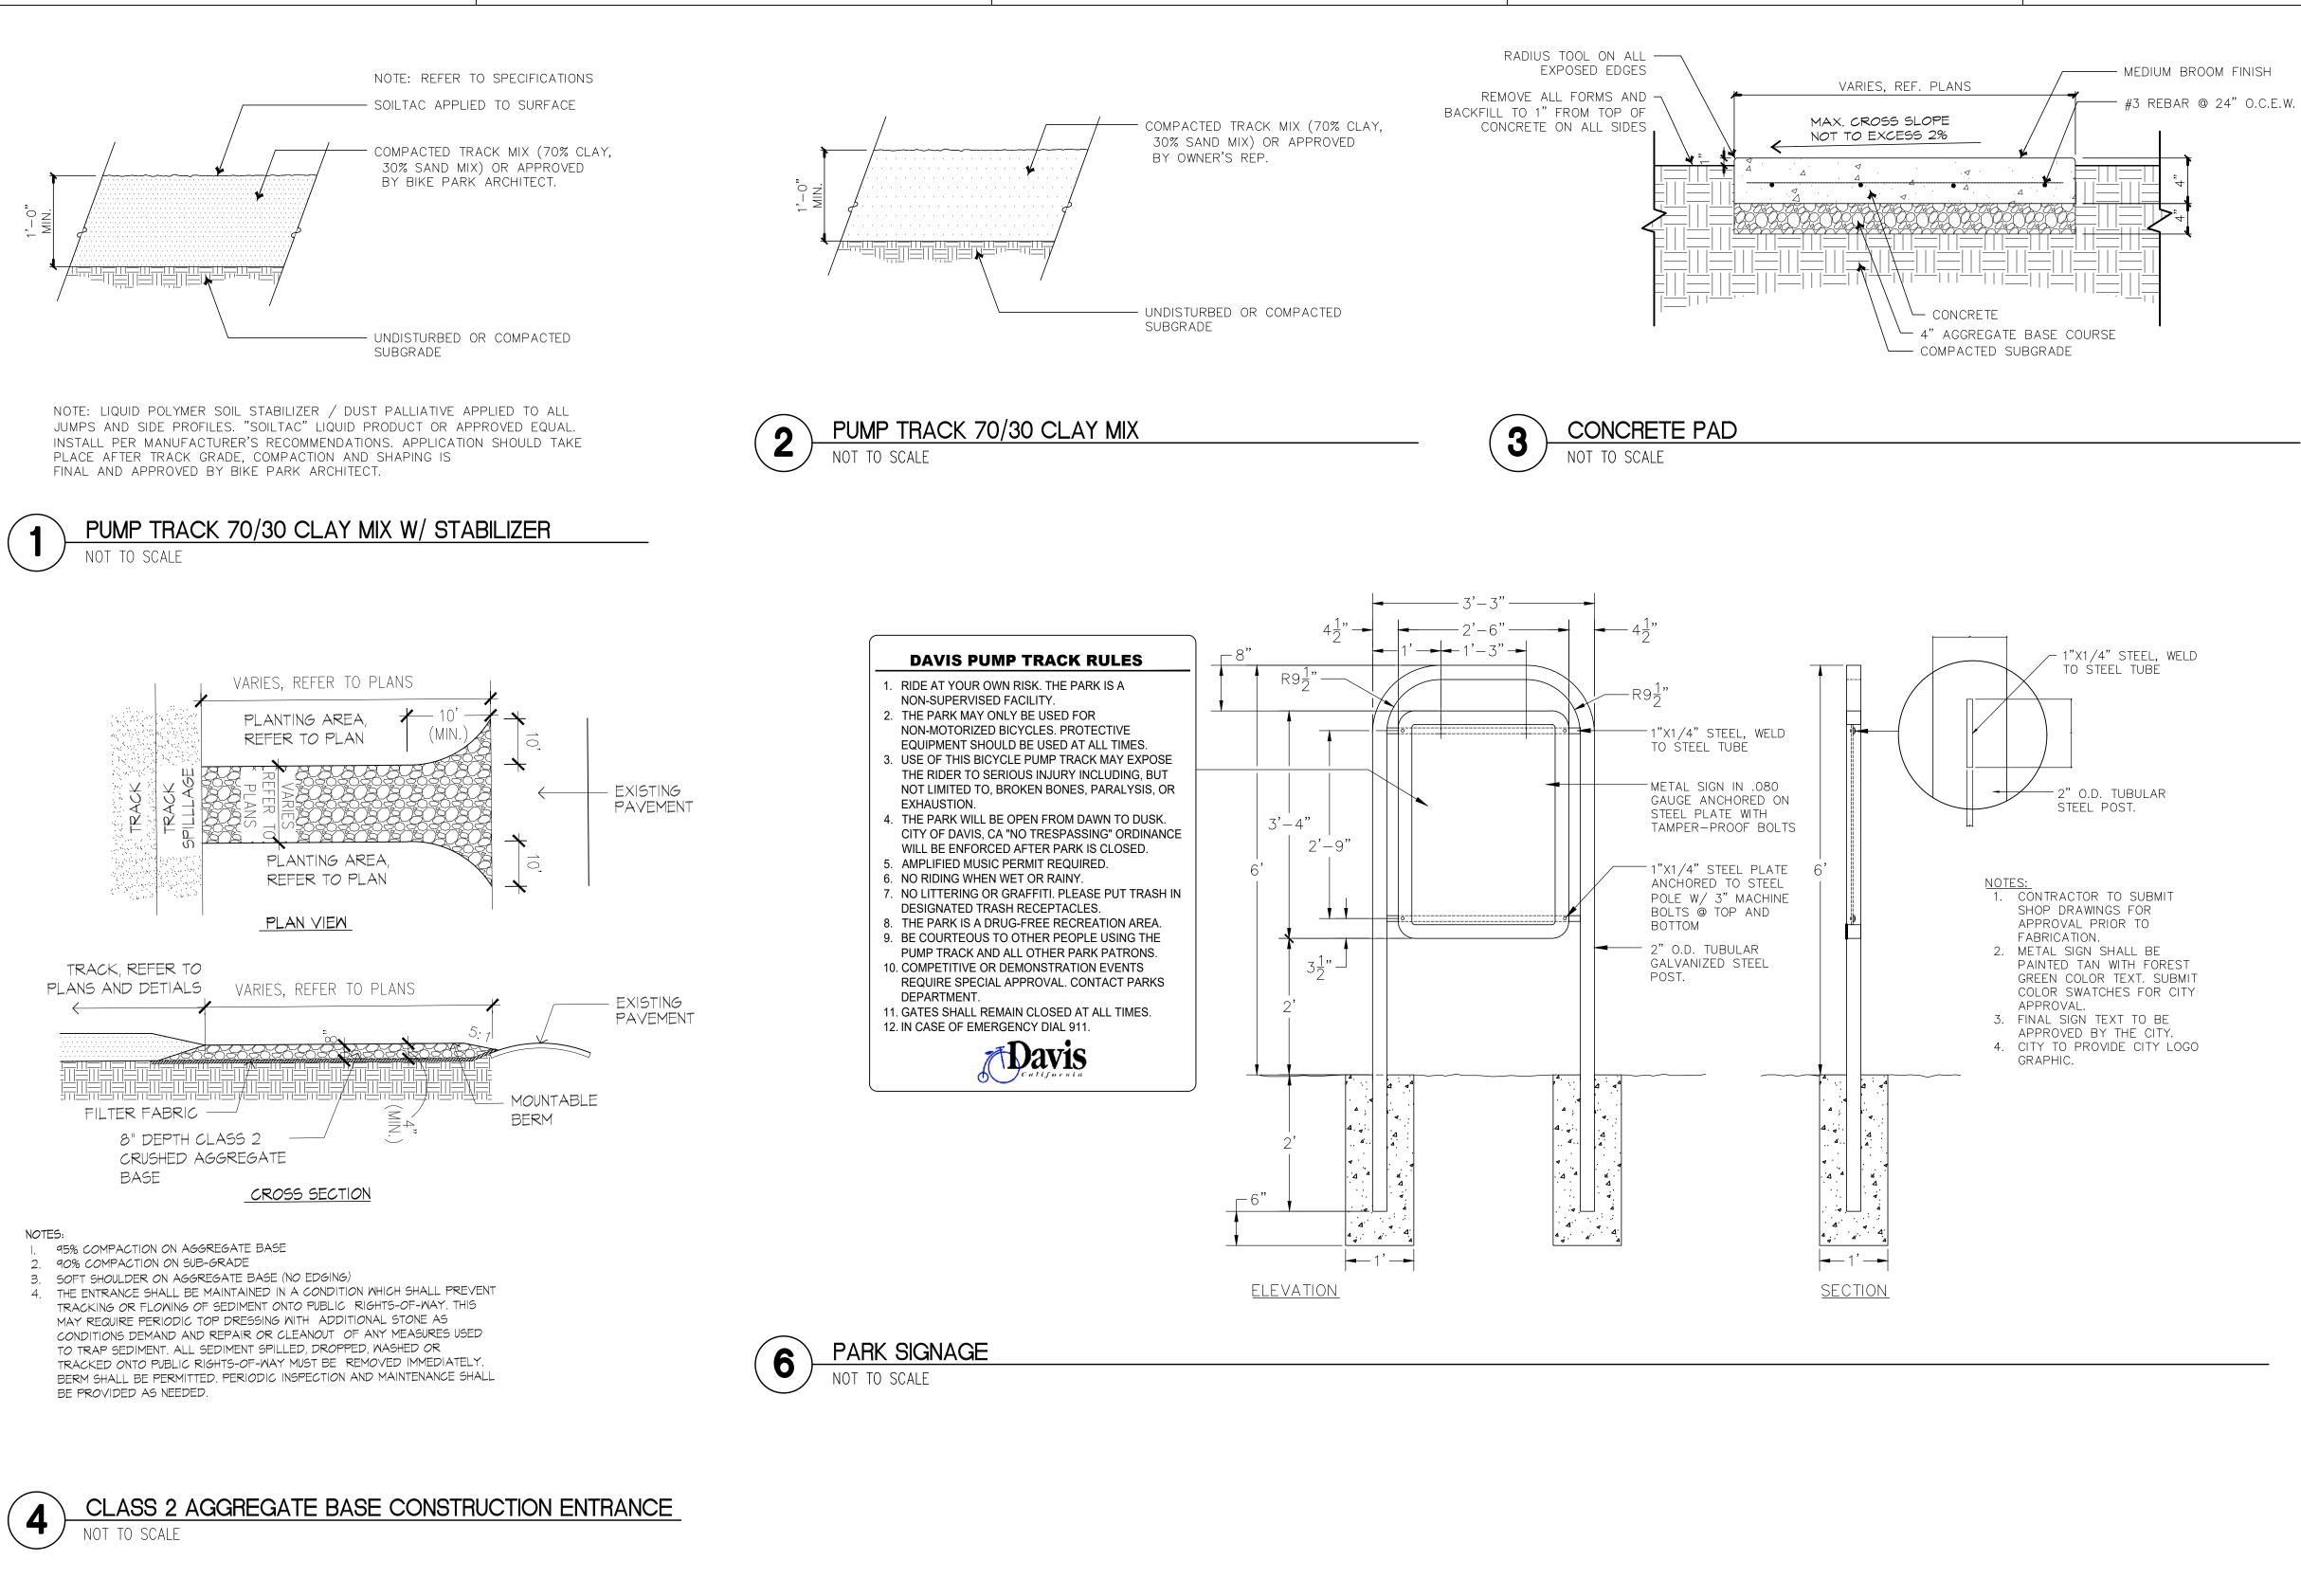


Consultant

MATERIAL LEGEND

COMPACTED TRACK MIX (95% COMPACTION) (70% CLAY, 30% SAND MIX), WITH STABILIZER; OR APPROVED BY OWNER'S REP.




COMPACTED TRACK MIX (95% COMPACTION) (70% CLAY, 30% SAND MIX) OR APPROVED BY OWNER'S REP.

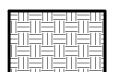

COMPACTED SUBGRADE (90% COMPACTION)



CONCRETE

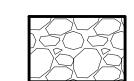


CLASS 2 CRUSHED ROCK AGGREGATE (95% COMPACTION)

GENERAL NOTES:

- 1. CONTRACTOR SHALL HAVE KNOWLEDGE AND EXPERIENCE OF BIKE PARK CONSTRUCTION. APPLICATION AND FINISHING TO PROPERLY INTERPRET SECTIONS/ PROFILES.
- 2. SECTIONS/PROFILES ARE AT THE DISCRETION OF BIKE PARK CONSTRUCTOR, AND SUBJECT TO CHANGE BOTH LOCATION AND SHAPE.



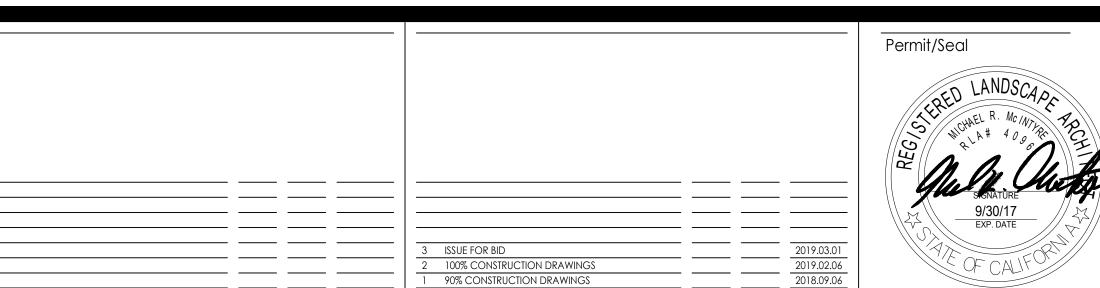

By Appd YYYY.MM.DD

By Appd YYYY.MM.DD

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Client/Project CITY OF DAVIS

PUMP TRACK DETAILS

DAVIS COMMUNITY PARK PUMP TRACK


Davis, California

File Name: 222011228_7.0_DETAILS

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 2019.03.01

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Project No. Scale 222011228 Drawing No. Revision Sheet C7.0 10 of 17

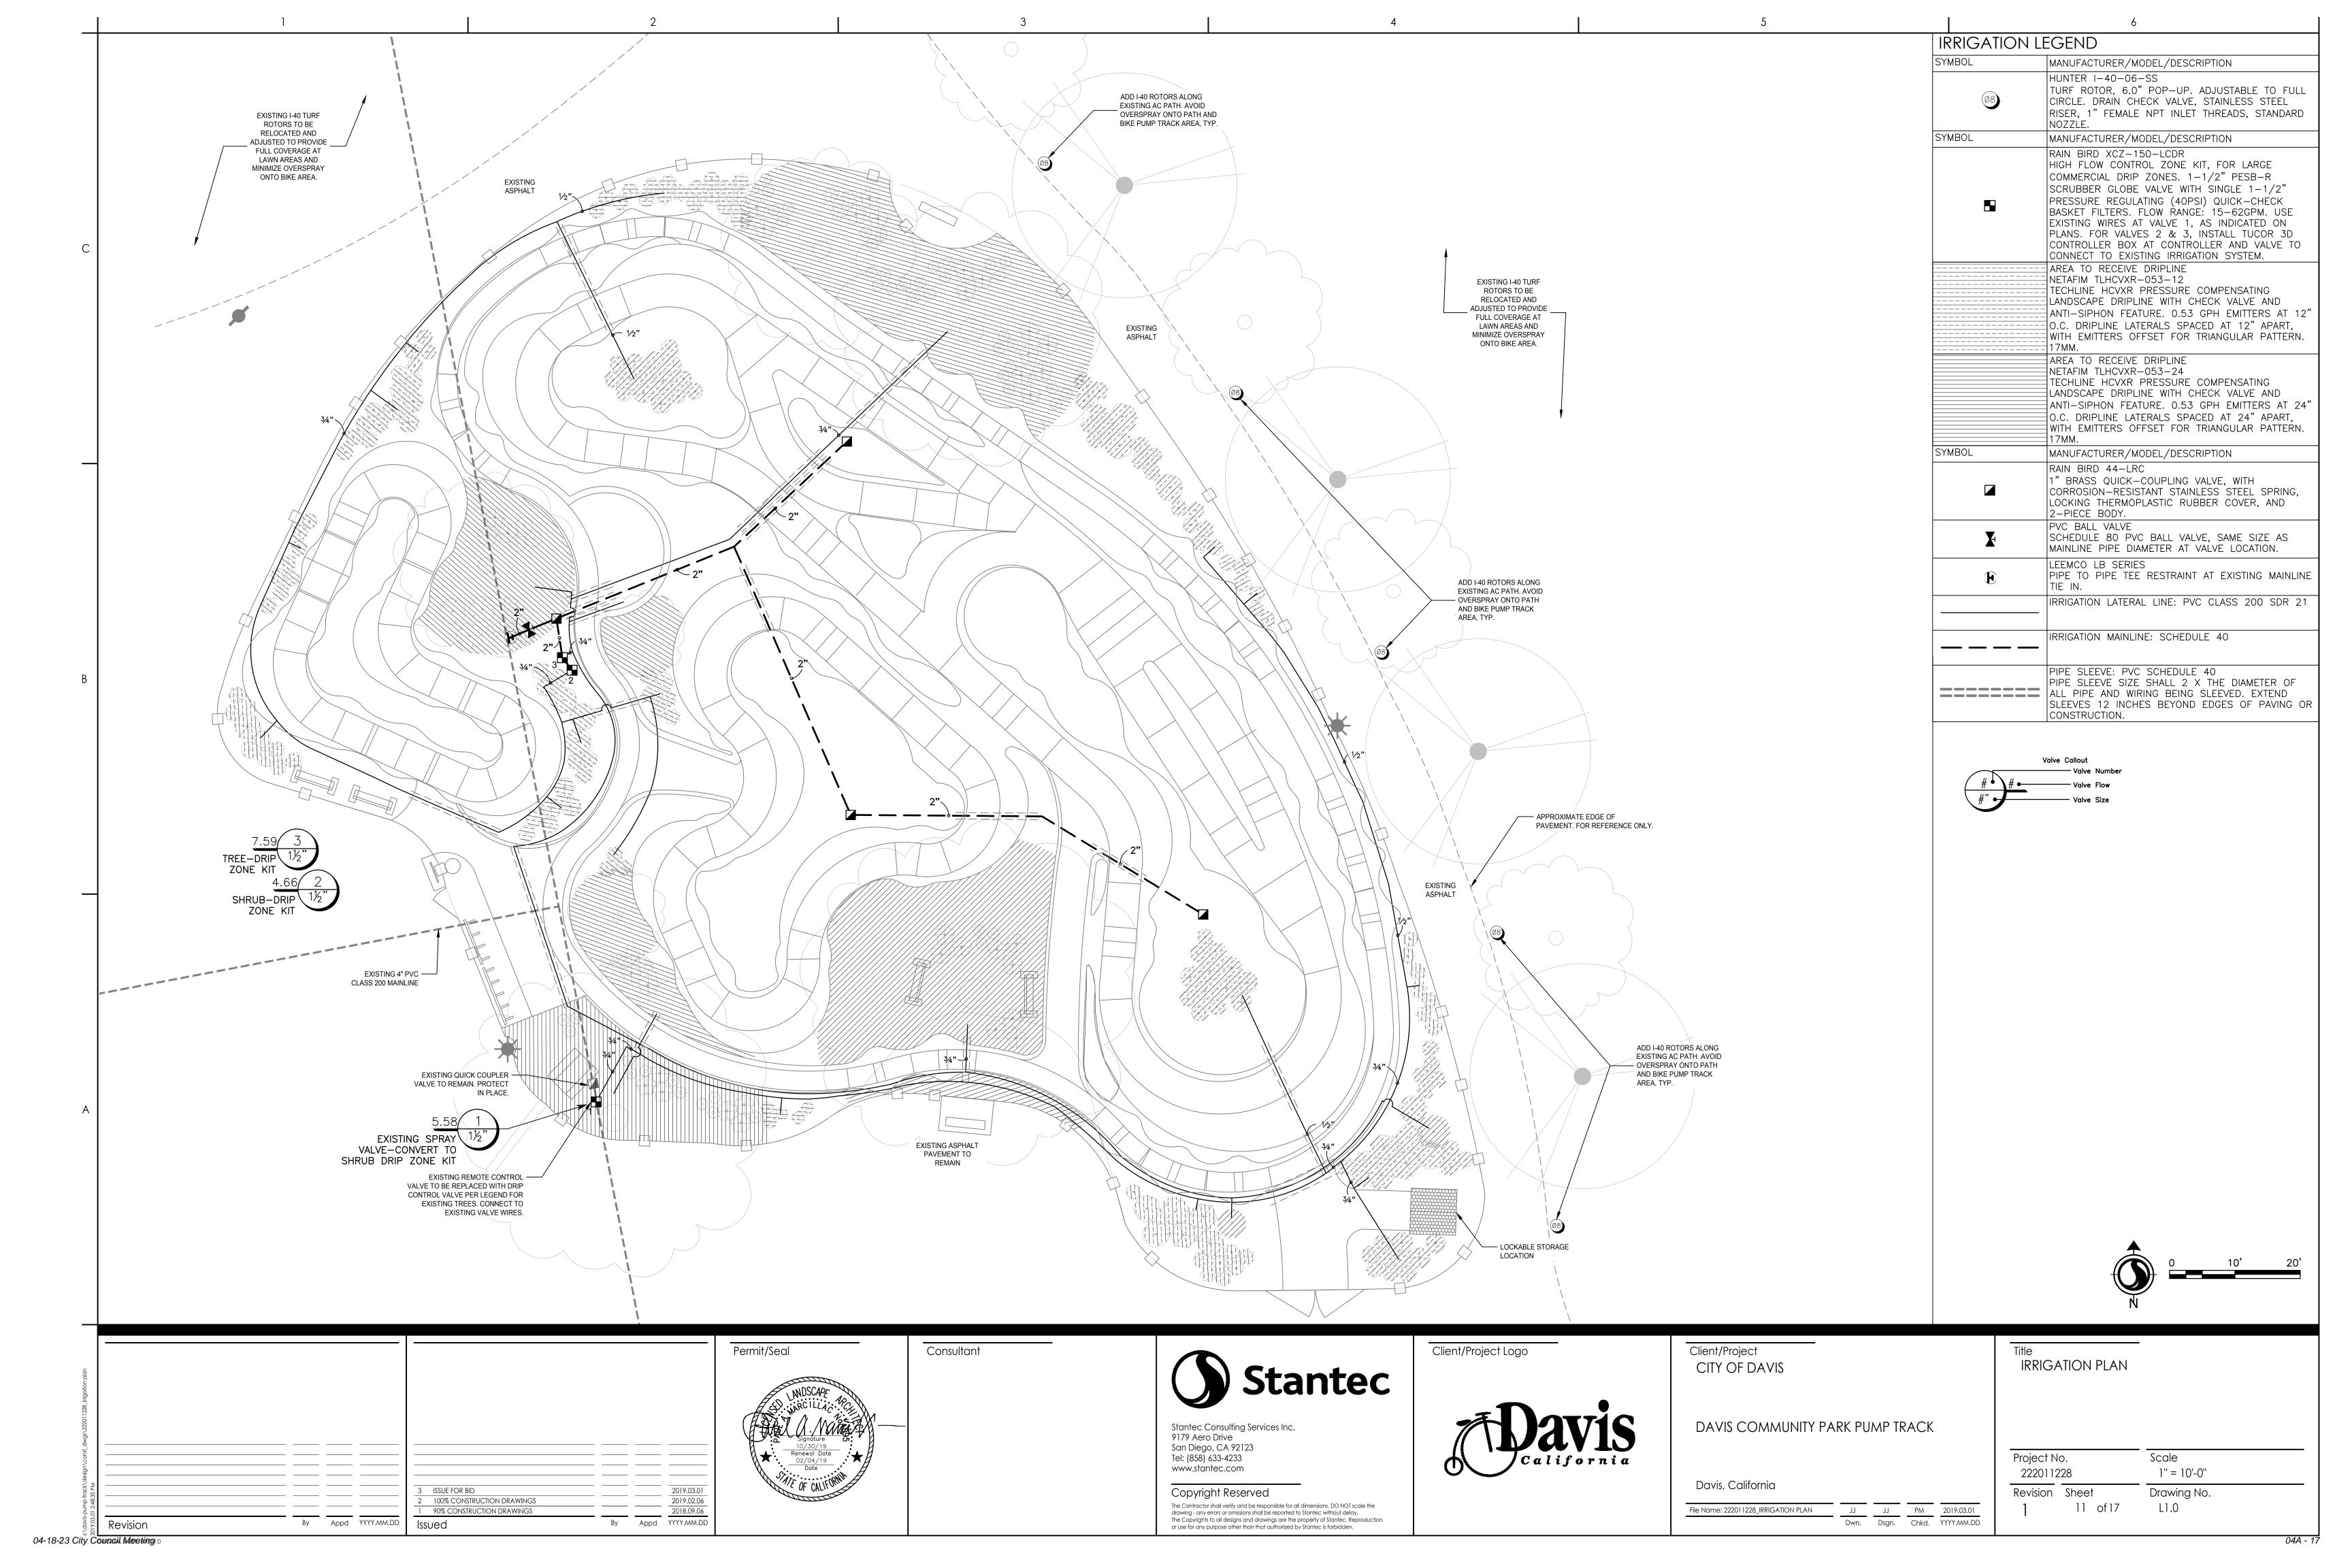

ETO = REFERENCE EVAPOTRANSPIRATION (INCHES PER YEAR)

IRRIGATION CALCULATIONS

THE MAXIMUM APPLIED WATER ALLOWANCE SHALL BE CALCULATED USING THE FOLLOWING FORMULA:

MAWA = (ETo)(0.62)[(ETAF X LA) + (1-(ETAF) X SLA)]

MAWA = MAXIMUM APPLIED WATER ALLOWANCE

0.62 = CONVERSION FACTOR (TO GALLONS PER SQUARE FOOT) ETAF = 0.45 FOR NON-RESIDENTIAL AREAS, 0.55 FOR RESIDENTIAL AREAS LA = LANDSCAPED AREA INCLUDES SPECIAL LANDSCAPE AREA (SQUARE FEET)

SLA = PORTION OF LANDSCAPE AREA IDENTIFIED AS SPECIAL LANDSCAPE AREA (SQUARE FEET)

MAWA = (52.5 IN/YR)(0.62)[(0.45 X 5,572 SF) + (0.55 X 0 SF)] = 81,616GALLONS PER YEAR

THE ESTIMATED TOTAL WATER USE (ETWU) SHALL BE CALCULATED USING THE FOLLOWING FORMULA:

ETWU = (ETo)(0.62)(ETAF)(AREA)

ETWU = ESTIMATED TOTAL WATER USE PER YEAR (GALLONS PER YEAR)

ETO = REFERENCE EVAPOTRANSPIRATION (INCHES PER YEAR)

0.62 = CONVERSION FACTOR (TO GALLONS PER SQUARE FOOT) ETAF = PLANT FACTOR DIVIDED BY IRRIGATION EFFICIENCY (PF/IE)

AREA = HYDROZONE AREA (SQUARE FEET)PF = PLANT FACTOR FROM WUCOLS

IE = IRRIGATION EFFICIENCY (MINIMUM 0.71)

WATER EFFICIENT LANDSCAPE WORKSHEET

Witch Entrolett Butbook E Worktonie						
LANDSO	CAPE AR	EAS				
ETo	PF	ΙE	ETAF (PF/IE)	AREA (SQ. FT.)	ETAF X AREA	ETWU
52.5	0.20	.81	0.25	4,486.00	1,107.65	36,054.15
			TOTALS:	4,486.00	1,107.65	36,054.15
SPECIAL LANDSCAPE AREAS						
			1.00			0.00
			TOTALS:			0.00
ETWU TOTAL: 36						36,054.15
					MAWA TOTAL:	81,616
	ETo 52.5	ETo PF 52.5 0.20	LANDSCAPE AREAS ETo PF IE 52.5 0.20 .81	LANDSCAPE AREAS ETO PF IE ETAF (PF/IE) 52.5 0.20 .81 0.25 TOTALS: LANDSCAPE AREAS 1.00	LANDSCAPE AREAS ETO PF IE ETAF (PF/IE) AREA (SQ. FT.) 52.5 0.20 .81 0.25 4,486.00 TOTALS: 4,486.00 LANDSCAPE AREAS 1.00	LANDSCAPE AREAS ETO PF IE ETAF (PF/IE) AREA (SQ. FT.) ETAF X AREA 52.5 0.20 .81 0.25 4,486.00 1,107.65 LANDSCAPE AREAS 1.00 TOTALS: ETWU TOTAL:

HYDROZONE INFORMATION TABLE

HYDROZ ONE	VALVE	IRRIGATION METHOD	PLANT TYPE	WATER USE	AREA (SQ. FT.)	% OF LANDSCA PE
А	1	DRIP	SHRUB	LOW	617	13.75%
А	2	DRIP	SHRUB	LOW	447	9.96%
А	3	DRIP	TREE	LOW	3422	76.28%
					4486.00	100.00%

IRRIGATION NOTES

- WORK SHALL BE PERFORMED BY A CONTRACTOR WITH EITHER A CLASS "A" (GENERAL ENGINEERING) CONTRACTOR'S LICENSE OR C27 LANDSCAPING CONTRACTOR'S LICENSE. NO EXCEPTIONS.
- 2. THIS DESIGN IS DIAGRAMMATIC. ALL PIPING, VALVES, ETC., SHOWN WITHIN PAVED AREAS IS FOR DESIGN <u>LARIFICATION ONLY, AND SHALL BE INSTALLED IN PLANTING AREAS WHEREVER POSSIBLE. CONTRACTOR</u> SHALL LOCATE IRRIGATION PIPES AND EQUIPMENT FREE FROM ALL UTILITY AND SITE CONFLICTS. ALL DIMENSIONS, QUANTITIES AND MATERIALS SHALL BE VERIFIED BY CONTRACTOR. CONTRACTOR TO INSTALL ADDITIONAL IRRIGATION, AS NEEDED, TO PROVIDE ADEQUATE COVERAGE, AT NO ADDITIONAL COST TO THE
- 3. ALL LOCAL CODES AND ORDINANCES SHALL BE COMPLIED WITH. IF THERE IS A CONFLICT, THE CONTRACTOR SHALL NOTIFY THE OWNER IMMEDIATELY IN WRITING.
- 4. A MINIMUM OF TWO WORKING DAYS PRIOR TO PERFORMING ANY DIGGING, CALL UNDERGROUND SERVICE ALERT AT 1-800-642-2444 FOR INFORMATION ON THE LOCATION OF UNDERGROUND UTILITIES.
- 5. THE IRRIGATION SYSTEM IS DESIGNED TO OPERATE WITH A MINIMUM STATIC WATER PRESSURE OF 40 PSI AT THE POINT OF CONNECTION. THE CONTRACTOR SHALL VERIFY THE POINT OF CONNECTION PRESSURE ON-SITE PRIOR TO INSTALLATION OF ANY IRRIGATION WORK. IF THERE IS A DISCREPANCY, THE CONTRACTOR SHALL NOTIFY THE OWNER IMMEDIATELY IN WRITING SO ADJUSTMENTS CAN BE MADE. CONTRACTOR SHALL NOT PROCEED ANY FURTHER WITH INSTALLATION OF THE SYSTEM UNTIL NECESSARY DESIGN REVISIONS HAVE BEEN DETERMINED BY THE OWNER.
- 6. THE IRRIGATION SYSTEM MAXIMUM FLOW RATE IS 40 GPM. THE CONTRACTOR SHALL PROGRAM THE AUTOMATIC CONTROLLER ACCORDING TO IRRIGATION WATERING SCHEDULE PROVIDED TO ALLOW FOR MULTIPLE VALVES TO RUN SIMULTANEOUSLY AND NOT EXCEED THE MAXIMUM FLOW RATE. ALL PLANT MATERIAL SHALL BE KEPT IN A HEALTHY, GROWING CONDITION WHILE MINIMIZING RUN-OFF OR EXCESSIVE WATERING.
- THE CONTRACTOR SHALL NOT WILLFULLY INSTALL THE IRRIGATION SYSTEM AS SHOWN ON THE DRAWINGS WHEN IT IS OBVIOUS IN THE FIELD THAT UNKNOWN OBSTRUCTIONS OR DIFFERENCES IN DIMENSIONS EXIST THAT MIGHT HAVE BEEN UNKNOWN DURING ENGINEERING. SUCH OBSTRUCTIONS SHALL BE BROUGHT TO THE ATTENTION OF THE OWNER IMMEDIATELY. IN THE EVENT THIS NOTIFICATION IS NOT PERFORMED, THE CONTRACTOR SHALL ASSUME FULL RESPONSIBILITY FOR ANY REVISIONS NECESSARY, AT NO ADDITIONAL COST TO OWNER.
- 8. IT IS THE CONTRACTOR'S RESPONSIBILITY TO DETERMINE THE LOCATION OF ANY UNDERGROUND UTILITIES, GRADE DIFFERENCES, WALL, RETAINING WALLS, AND STRUCTURES. DAMAGE CAUSED BY THE CONTRACTOR'S INSTALLATION SHALL BE REPAIRED TO THE SATISFACTION OF THE GOVERNING AGENCY AND/OR OWNER. THE CONTRACTOR SHALL BE RESPONSIBLE FOR ALL COSTS OF SUCH REPAIRS.
- 9. INSTALL ALL PIPE AND CONTROL WIRES IN LANDSCAPE BEDS AND IN COMMON TRENCHES WHEREVER POSSIBLE. THE LANDSCAPE CONTRACTOR SHALL COORDINATE HIS WORK WITH THE ELECTRICAL CONTRACTOR TO ASSURE IRRIGATION SYSTEM IS FULLY FUNCTIONING BEFORE PLANTING COMMENCES. THE LANDSCAPE CONTRACTOR SHALL BE RESPONSIBLE TO MAKE THE FINAL CONNECTION FROM THE ELECTRICAL SOURCE TO THE CONTROLLER.
- 10. ALL PIPING AND CONTROL WIRES UNDER PAVING SHALL BE INSTALLED IN SEPARATE SCHEDULE 40 SLEEVES. ALL WIRING UNDER PAVEMENTS SHALL BE INSTALLED IN PVC SCHEDULE 40 CONDUIT. ALL SLEEVES SHALL EXTEND TWELVE INCHES (12") BEYOND EDGE OF PAVEMENT, TRACK EDGES, AND/OR CURBS. ALL SLEEVES AND CONDUIT SHALL BE INSTALLED PRIOR TO THE PLACEMENT OF BASE MATERIALS AND PAVING. INSTALL SLEEVES AS NECESSARY OR AS REQUIRED PER PLANS. BACKFILL FOR SLEEVES SHALL BE COMPACTED TO THE SPECIFIED DENSITY FOR THE SUBGRADE. 11. SLEEVES:
- INSIDE DIAMETER OF SLEEVE SHALL BE A MINIMUM OF TWO (2) TIMES THE OUTER DIAMETER OF THE PIPE
- BEING SLEEVED. B. ALL CONTROL WIRE SLEEVES SHALL BE OF SUFFICIENT SIZE FOR THE REQUIRED NUMBER OF WIRES.
- C. CONTRACTOR IS RESPONSIBLE FOR COORDINATING PAVING INSTALLATION FOR PROPER INSTALLATION OF
- D. BACKFILL FOR SLEEVES SHALL BE COMPACTED TO SPECIFIED DENSITY FOR THE SUBGRADE. 12. THE CONTRACTOR SHALL LAY OUT ALL WORK PRIOR TO TRENCHING OPERATIONS TO DETERMINE IF MINOR
- MODIFICATIONS WILL BE REQUIRED. CONTRACTOR SHALL COORDINATE THE INSTALLATION OF ALL IRRIGATION MATERIALS, INCLUDING PIPE, WITH THE LANDSCAPE DRAWINGS TO AVOID INTERFERING WITH THE PLANTING OF TREES, SHRUBS, OR OTHER PLANTINGS. 13. CONTRACTOR SHALL COORDINATE ALL WORK WITH OTHER TRADES SO PROGRESS OF WORK IS NOT
- INTERRUPTED AND CAN BE COMPLETED IN A TIMELY MANNER.
- 14. HYDROSTATIC TESTING: PIPING SHALL BE COMPLETELY FLUSHED OF FOREIGN PARTICLES BEFORE ATTACHING IRRIGATION COMPONENTS. AFTER FLUSHING, AND WHEN ALL VALVES AND QUICK COUPLERS ARE IN PLACE, ALL MAIN SUPPLY LINES SHALL BE TESTED AT 100 POUNDS PER SQUARE INCH (100 PSI) WITH VALVES CLOSED MAINTAIN PRESSURE FOR A PERIOD OF NOT LESS THAN FOUR (4) CONSECUTIVE HOURS. ALL JOINTS SHOWING LEAKS SHALL BE CLEANED, REMADE, AND TESTED.
- 15. OPERATIONAL TESTING: PERFORM OPERATIONAL TESTING AFTER HYDROSTATIC TESTING IS COMPLETED. DEMONSTRATE TO THE OWNER THAT THE SYSTEM MEETS COVERAGE REQUIREMENTS (100%) AND THAT AUTOMATIC CONTROLS FUNCTION PROPERLY.
- 16. MAINTAIN A MINIMUM CLEARANCE OF FIVE FEET BETWEEN ALL MAIN LINES AND TREES.
- 17. ALL PIPING, RCV'S AND QCV'S SHALL BE INSTALLED IN PLANTING AREAS (PIPING MAY PASS UNDER PAVING AS
- REQUIRED). RCV'S AND QCV'S SHALL BE INSTALLED ADJACENT TO WALKWAYS OR PAVING. 18. SEE IRRIGATION DETAILS AND SPECIFICATIONS FOR ADDITIONAL INFORMATION.
- 19. ALL IRRIGATION EQUIPMENT NOT OTHERWISE DETAILED OR SPECIFIED SHALL BE INSTALLED PER

REQUIRED BY LENGTH PER MANUFACTURER'S SPECIFICATIONS.

- MANUFACTURER'S RECOMMENDATIONS AND SPECIFICATIONS. 20. ALL ELECTRICAL WIRE FROM CONTROLLER TO VALVES SHALL BE 14 GAUGE UL DIRECT BURIAL OR LARGER AS
- 21. CHECK VALVES SHALL BE INSTALLED PER MANUFACTURER'S RECOMMENDATIONS TO ELIMINATE LOW HEAD DRAINAGE. IT IS THE CONTRACTOR'S RESPONSIBILITY TO FIELD VERIFY ELEVATION CHANGE AND INSTALL IN-LINE CHECK VALVES AS NECESSARY WHERE CHANGE IN ELEVATION EXCEEDS THE MANUFACTURER'S PRODUCT SPECIFICATIONS.
- 22. INSTALLATION AND PERFORMANCE OF APPROVED SUBSTITUTIONS ARE THE CONTRACTOR'S RESPONSIBILITY. ANY CHANGES REQUIRED FOR INSTALLATION OF ANY APPROVED SUBSTITUTION MUST BE MADE TO THE SATISFACTION OF THE OWNER WITHOUT ADDITIONAL COST TO OWNER.
- 23. CONTRACTOR SHALL UNCONDITIONALLY GUARANTEE THE IRRIGATION SYSTEM FOR A PERIOD OF ONE (1) YEAR FROM THE DATE OF FINAL ACCEPTANCE. MANUFACTURER WARRANTIES SHALL NOT SUPERSEDE THIS GUARANTEE AS CONTRACTOR SHALL BE FULLY LIABLE FOR REPAIRS/REPLACEMENT OF FAILED MATERIALS/WORKMANSHIP.
- 24. FOR VALVES 2 & 3, USE "ADD-A-ZONE+" OR EQUAL AND CONNECT TO TWO AVAILABLE STATIONS AT EXISTING CONTROLLER. RE-USE WIRES FROM EXISTING VALVE #1, NO ADDITIONAL WIRES AVAILABLE IN TURF AREA.

Permit/Seal

2019.02.06

Appd YYYY.MM.DD

100% CONSTRUCTION DRAWINGS

90% CONSTRUCTION DRAWINGS

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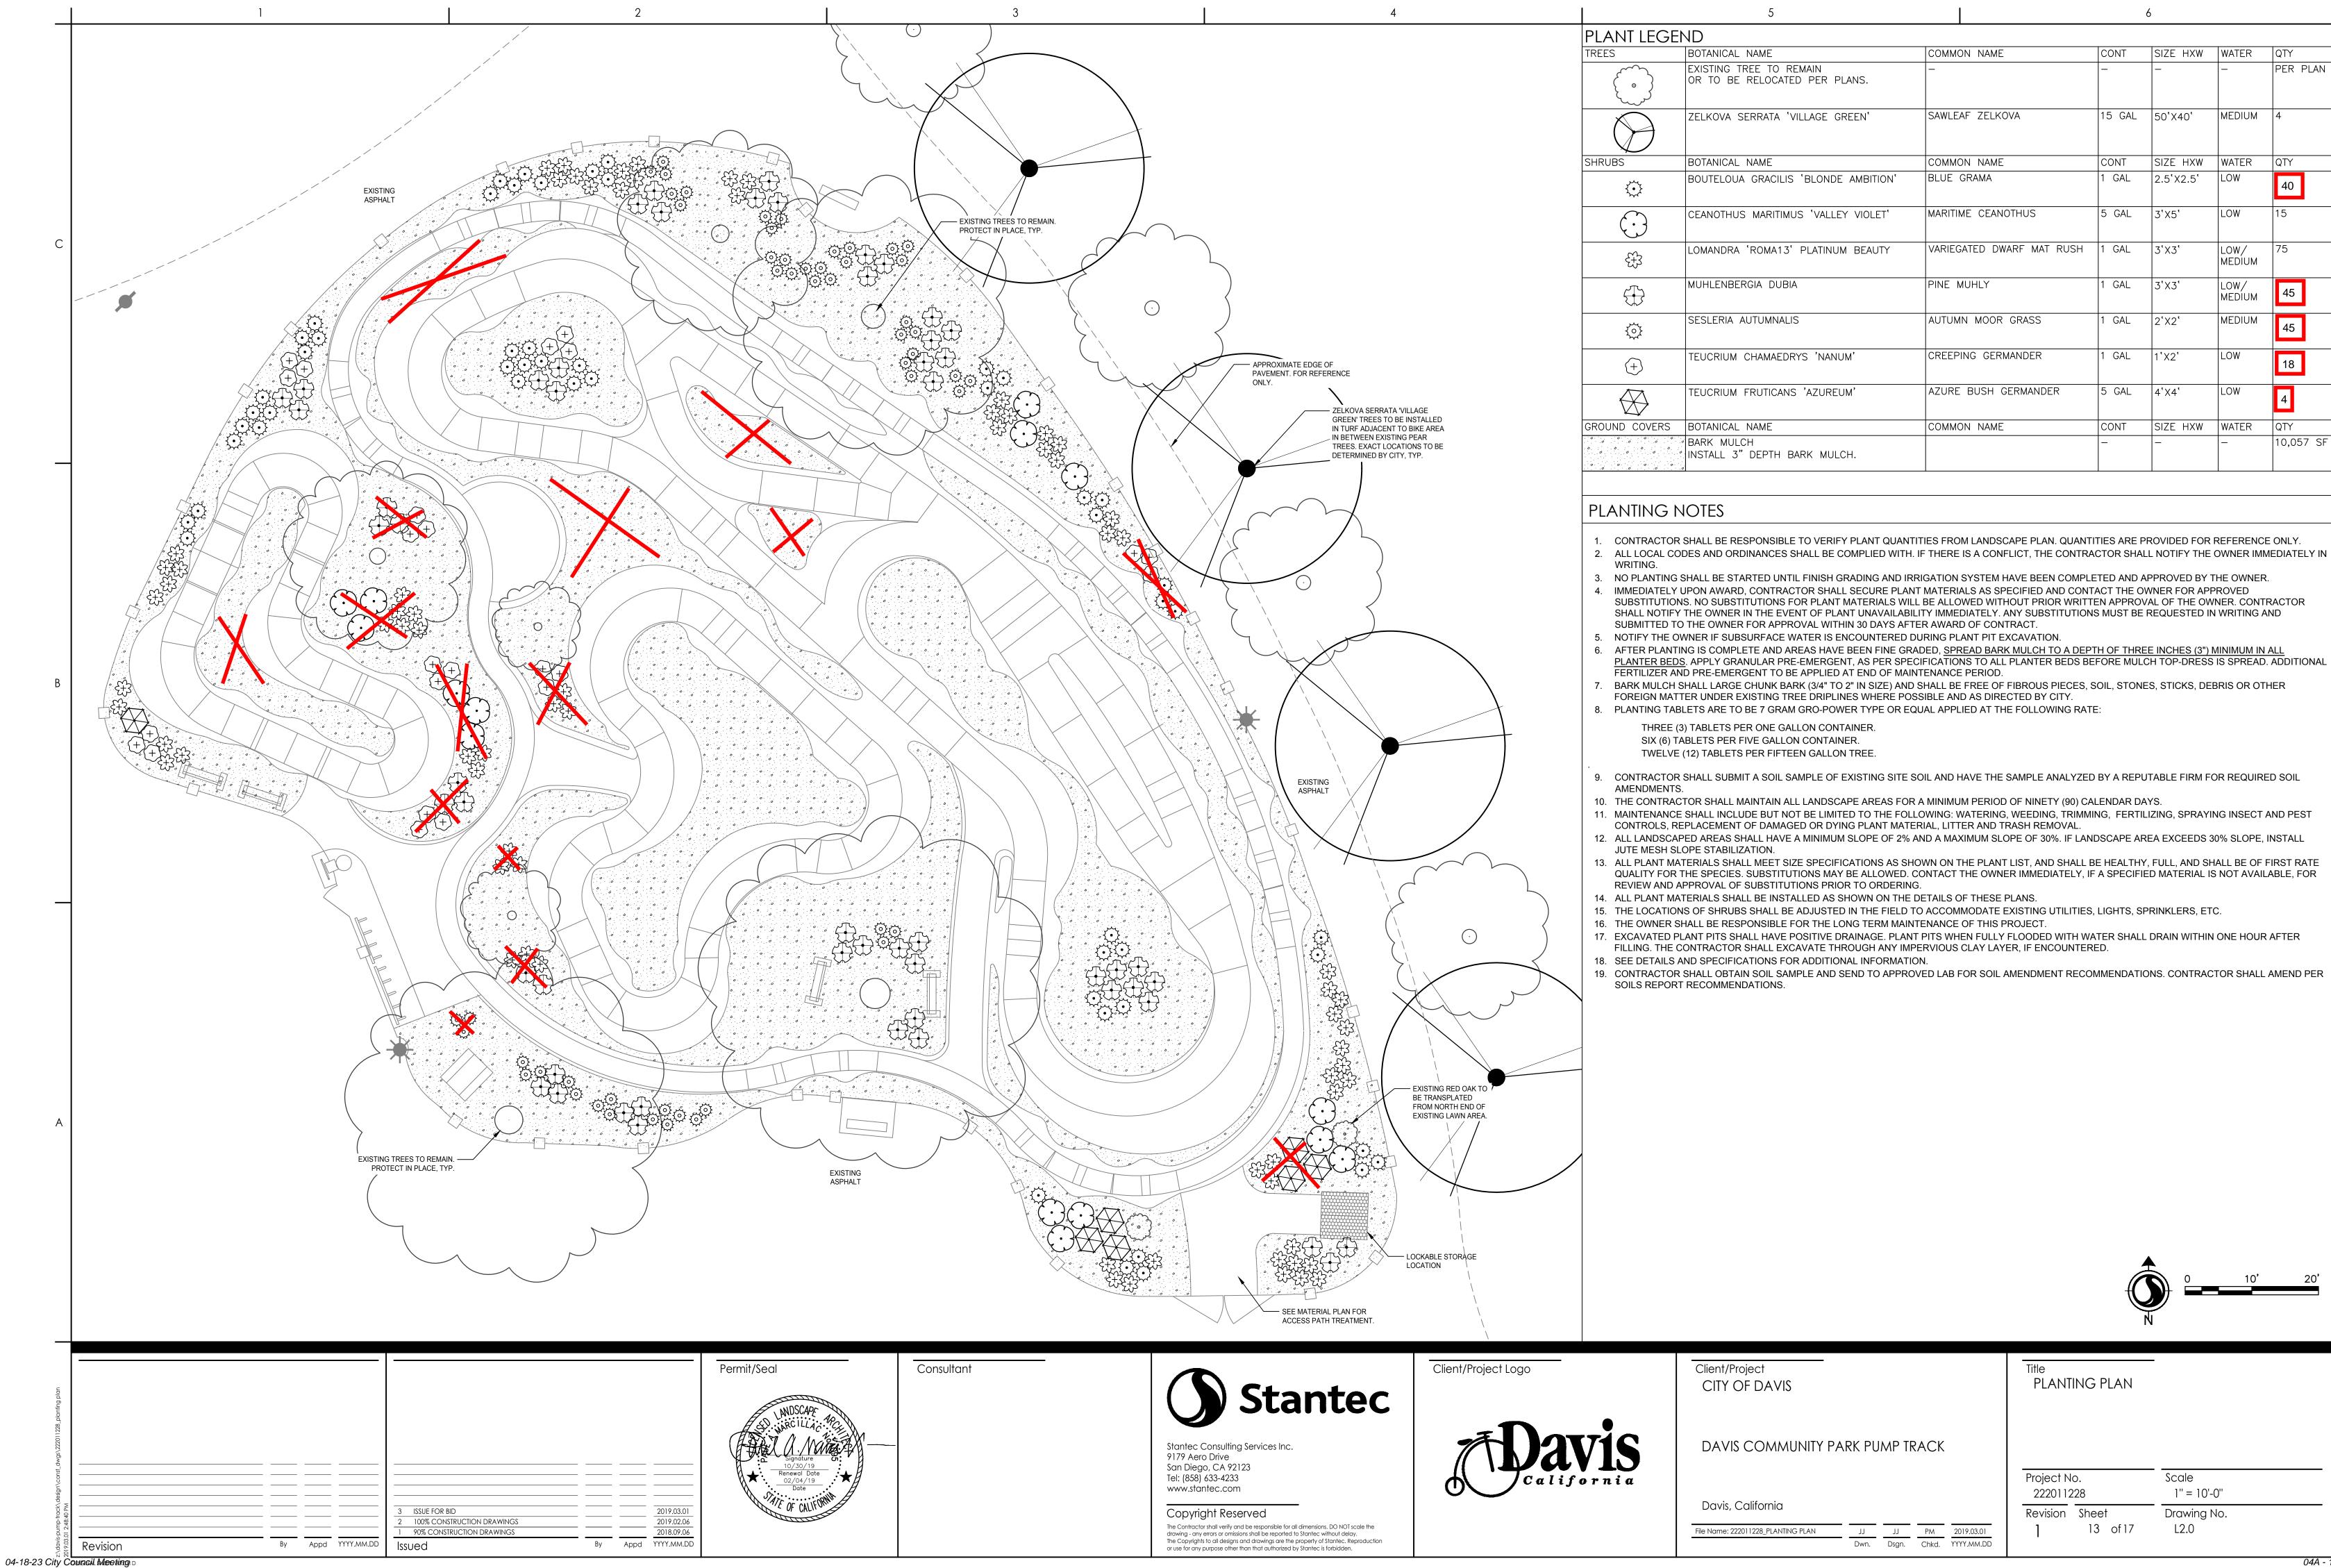
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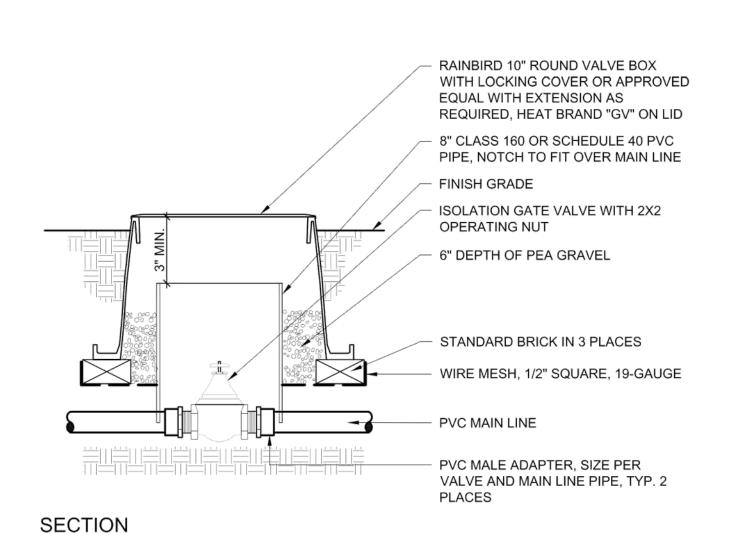
Davis, California

File Name: 222011228_IRRIGATION PLAN Dwn. Dsgn. Chkd. YYYY.MM.DD IRRIGATION CALCULATIONS & NOTES

Project No. Scale NO SCALE 222011228 Revision Sheet Drawing No. 12 of 17 L1.1

Revision







1. INSTALL GATE VALVES A MINIMUM OF 24" FROM STRUCTURES.

- 2. INSTALL TRIANGULAR BOX AND LID FOR NON-POTABLE APPLICATIONS. INSTALL CHRISTY G05 CONCRETE BOX AND IRON LID IN HARDSCAPE.
- 3. COMPACT SOIL AROUND VALVE BOX TO SAME DENSITY AS UNDISTURBED ADJACENT SOIL. 4. VALVE BOX SHALL BE INSTALLED 3" ABOVE FINISH GRADE IN MULCH AREAS, AND 1" ABOVE
- FINISH GRADE IN TURF AREAS. 5. REFER TO SPECIFICATIONS AND PLAN SHEETS FOR MORE INFORMATION.

- Dovice	GATE VALVE - 2-1/2" AND SMALLER			
(1) Javis	PARKS & COMMUNITY SERVICES			120
California	SCALE: NTS	REVISED 2016	DALE SUMERSILLE PARKS & COMMUNITY SERVICES DIRECTOR	130
				24 May 2016

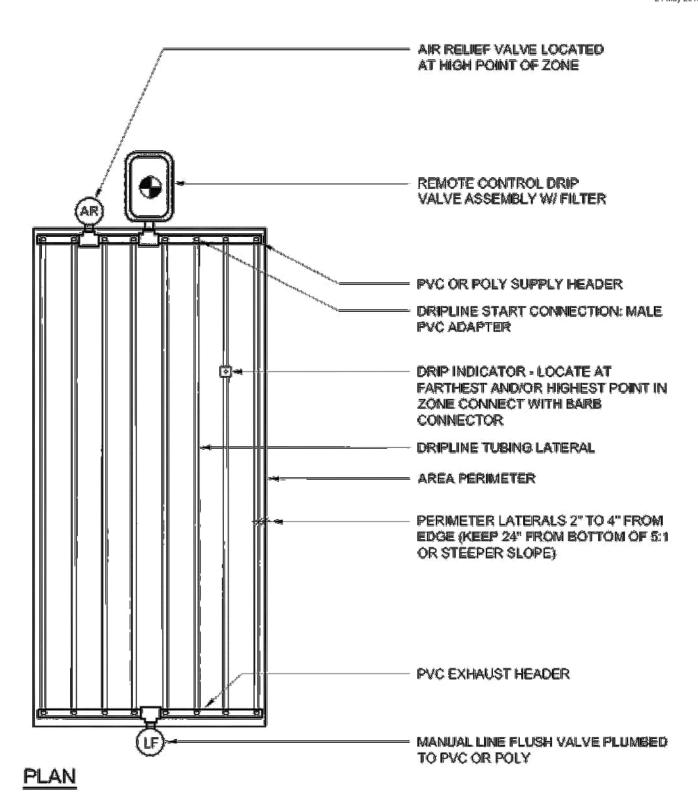

- Davic	DRIPLINE- END FEED LAYOUT			
(Vavis	PARKS & COMMUNITY SERVICES			4EA
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				24 May 2016

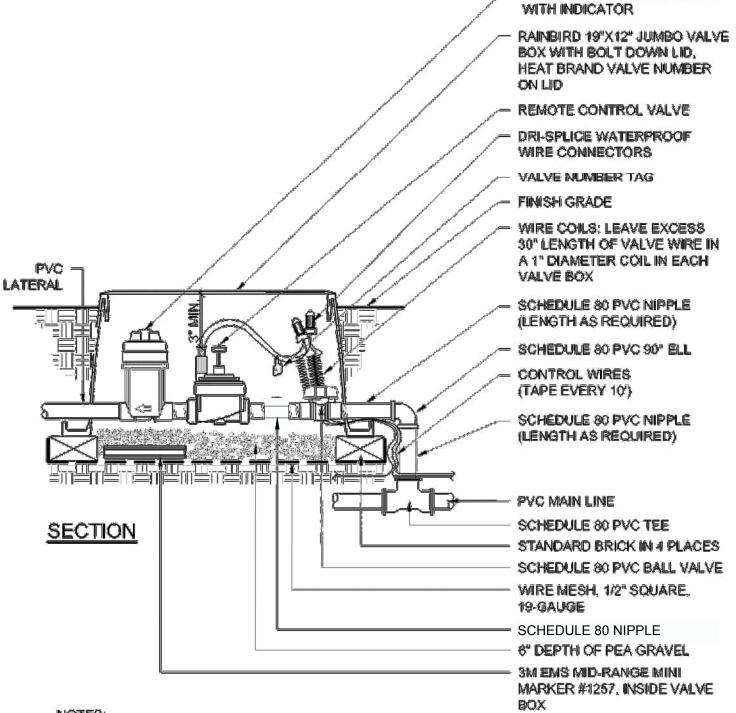


PRESSURE REDUCING FILTER

1. ALL WIRE TO BE INSTALLED AS PER LOCAL CODE.

- 2. COMPACT SOIL AROUND VALVE BOX TO SAME DENSITY AS UNDISTURBED ADJACENT SOIL.
- ONLY ONE (1) RCV TO BE INSTALLED IN EACH VALVE BOX.
- 4. VALVE BOX SHALL BE INSTALLED 3" ABOVE FINISH GRADE IN MULCH AREAS, AND 1" ABOVE FINISH GRADE IN TURF AREAS.


Dovice	DRIP REMOTE	CONTROL V	ALVE	
(Vavis	PARKS & COMMUNITY SERVICES			422
California	SCALE: NTS	REVISED 2016	BALE SUMERSOLLE PARKS A COMMUNITY SERVICES DIRECTION	133 Rection
AR CF		PON LINE	RELIEF VALVE LOCATED AT H NT OF ZONE : FLUSH VALVE PLUMBED TO I : EXHAUST HEADER	

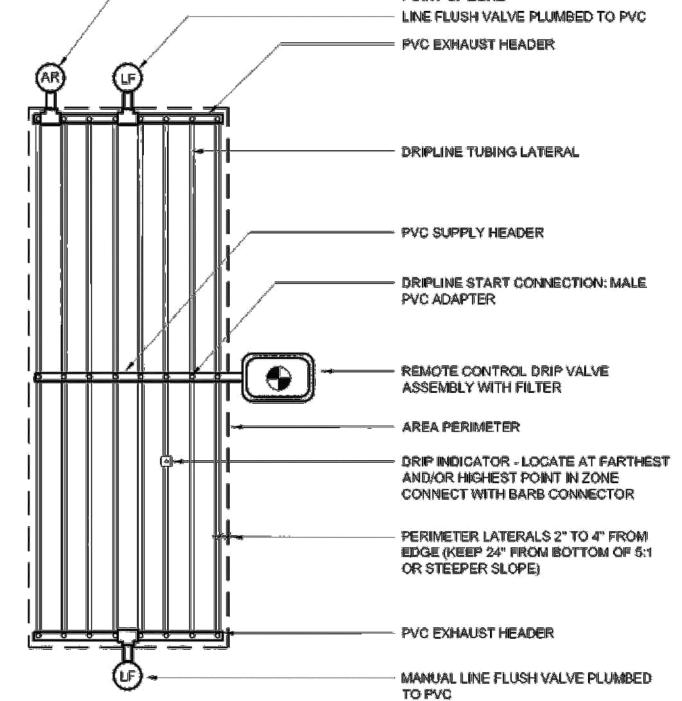

<u>PLAN</u>


- Dovice	DRIPLINE-	MIDDLE FEED L	AYOUT	
/\Davis	PARKS & COMMUNITY SERVICES			454
California	SCALE: NTS	REVISED 2016	BALE SUMERSHILE PARKS A COMMUNITY SERVICES DIRECTOR	151
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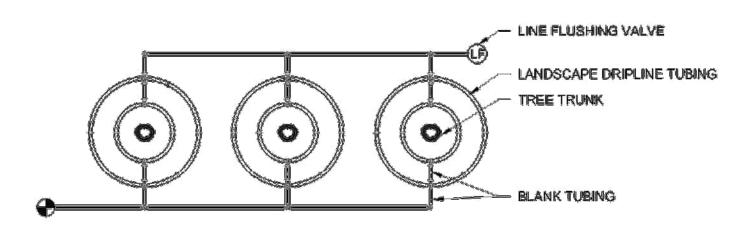
- COMPACT SOIL AROUND VALVE BOX TO SAME DENSITY AS UNDISTURBED ADJACENT SOIL. 2. VALVE BOX SHALL BE INSTALLED 3" ABOVE FINISH GRADE IN MULCH AREAS, AND 1" ABOVE
- FINISH GRADE IN TURF AREAS. 3. PROVIDE ONE (1) QUICK COUPLER KEY PER EVERY FOUR (4) QUICK COUPLERS INSTALLED PER PROJECT.

Dovrig	QUICK COUPLING VALVE			
/\Vavis	PARKS & COMMUNITY SERVICES			120
California	SCALE: NTS	REVISED 2016	DALE SUMERSILLE PARKS & COMMUNITY SERVICES DIRECTOR	139
				1 March 2019

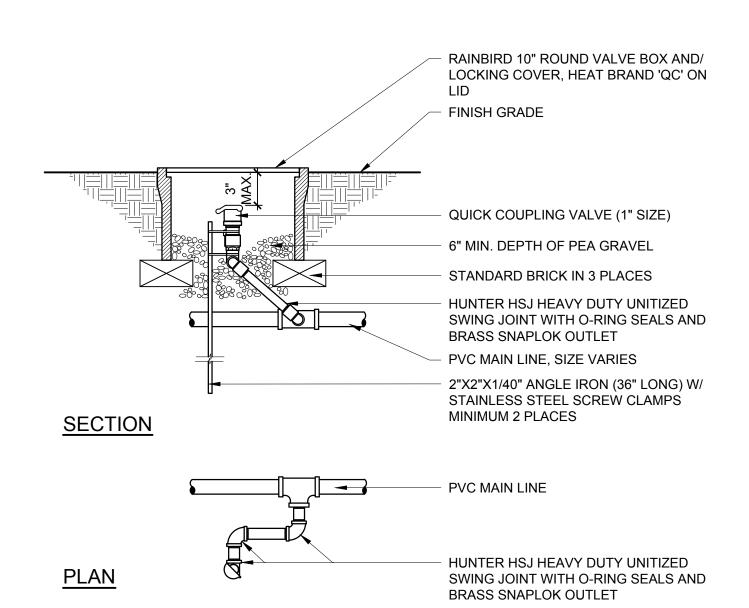


- Dovrio	DRIPLINE-	DRIPLINE- TRIANGULAR LAYOUT		
MUAVIS		UNITY SERVICES		450
Cottfornia	SCALE: NTS	REVISED 2016	DAJE SUMERSHLE PARKS A COMMUNITY SERWICES DIRECTOR	152

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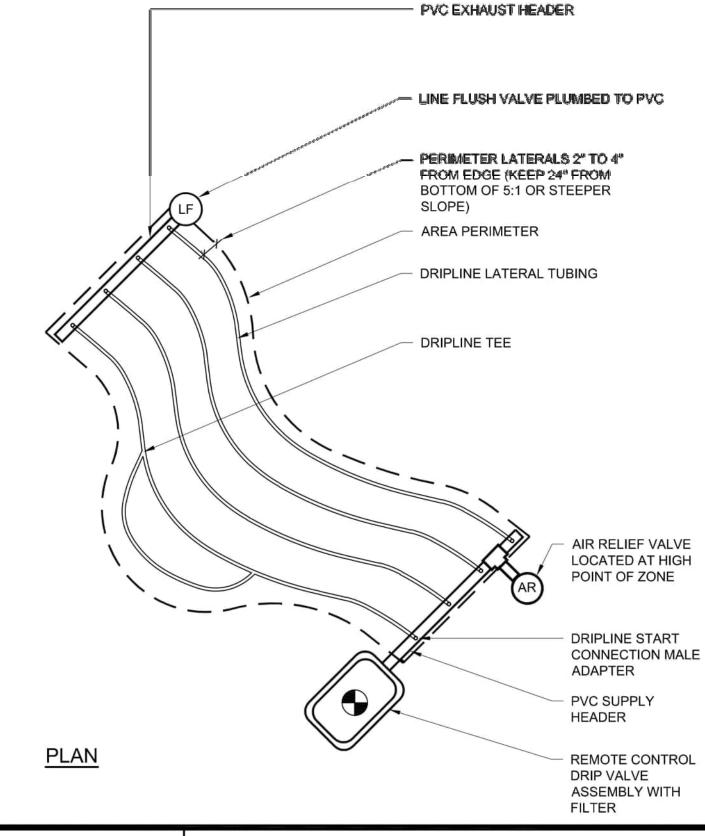
PLAN (MULTIPLE TREES)

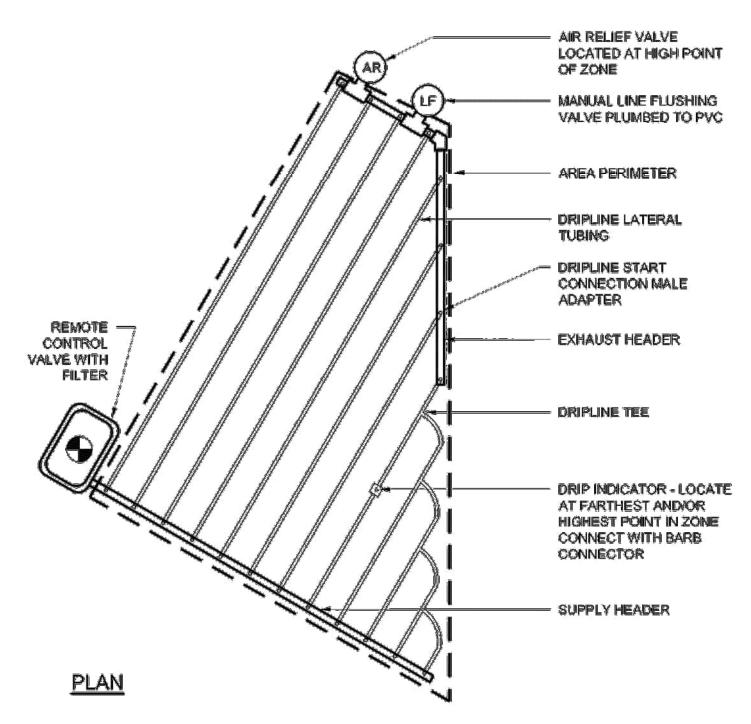

PLAN (SINGLE TREE)

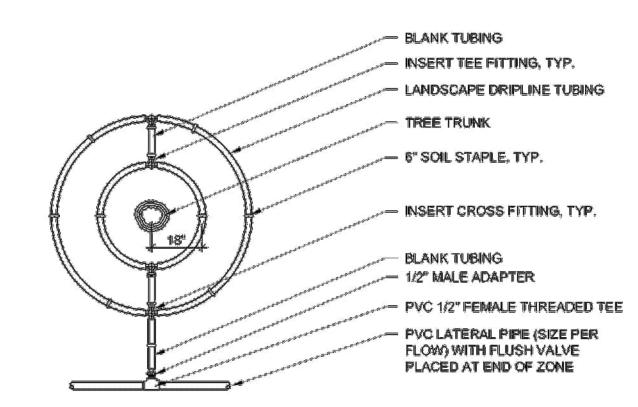1. INSTALL FIRST LOOP 18" FROM CENTER OF TREE TRUNK, INSTALL EACH ADDITIONAL LOOP PER DRIPLINE SPACING REQUIREMENTS IN IRRIGATION SCHEDULE.


- Davic	DRIPLINE - TREE				
(Vavis	PARKS & COMMUNITY SERVICES			AEE	
Catifornia	SCALE: NTS	REVISED 2016	DALE SUMERSHILE	155	
	10.20	**		24 May 2016	




Davis California	DRIPLINE-	DRIPLINE- LAYOUT FOR CURVES				
	PARKS & COMM	UNITY SERVICES		153		
	SCALE: NTS	REVISED 2016	DALE SUMERSILLE PARKS & COMMUNITY SERVICES DIRECTOR			
			7.7	24 May 2016		

Revision Sheet

14 of 17

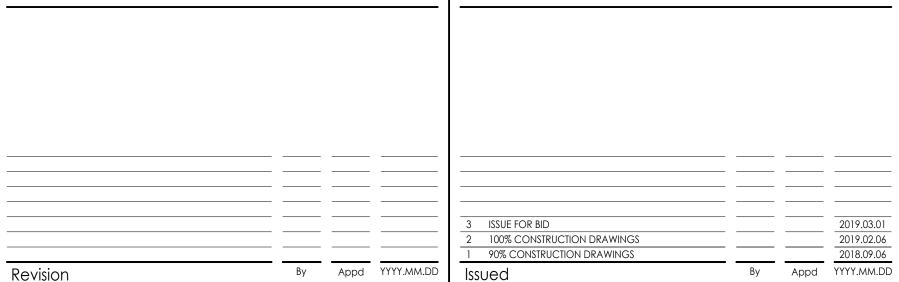

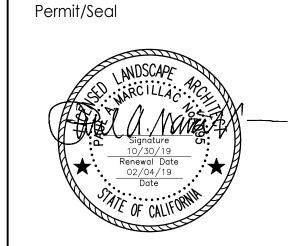



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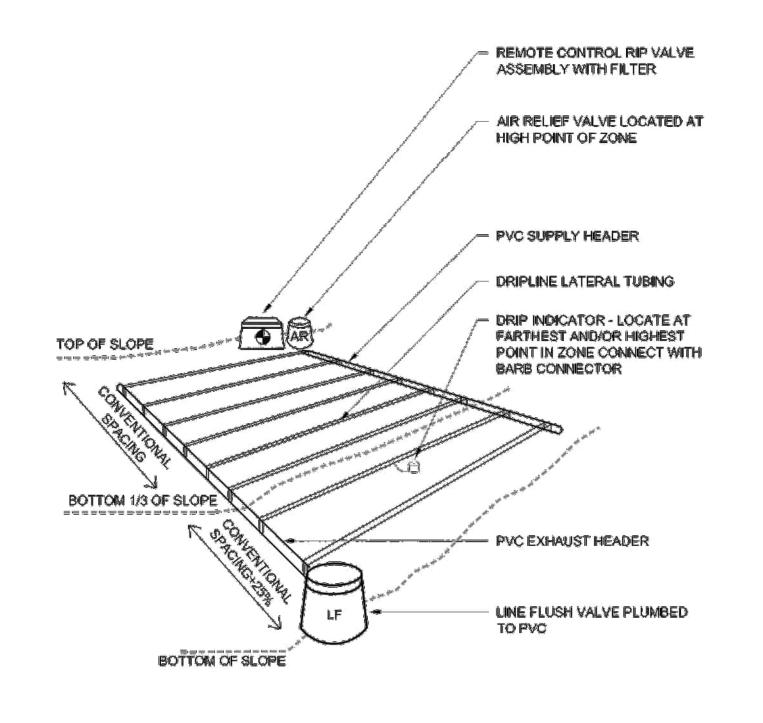
Davis, California
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 File Name: 222011228_LANDSCAPE DETAILS

LANDSCAPE DETAILS Project No. Scale **AS SHOWN** 222011228


Drawing No.

L3.0



1. ALIGN DRIPLINE LATERALS PARALLEL TO THE CONTOURS OF THE SLOPE.

- Dovice	DRIPLINE- LAYOUT ON SLOPE			
	PARKS & COMMUNIT	Y SERVICES		4E4
California	SCALE: NTS	REVISED 2016	BÁLE SUMERSIULE PARKS A COMMUNITY SERVICES DIRECTION	154

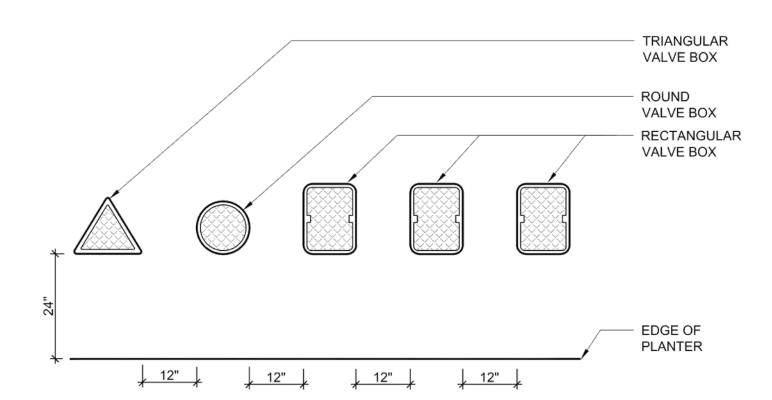

PLAN

- 1. CENTER VALVE BOXES DIRECTLY OVER VALVES TO FACILITATE SERVICING. 2. FINISH GRADE AROUND BOXES TO BE KEPT BELOW VALVE BOX LID:
- 1" IN TURF AREAS 3" IN MULCH AREAS
- 3. SET VALVES IN GROUNDCOVER/SHRUB AREAS WHENEVER POSSIBLE. INSTALL IN TURF ONLY
- IF GROUND COVER DOES NOT EXIST ADJACENT TO TURF.
- 4. SET BOXES PARALLEL TO EACH OTHER AND PERPENDICULAR TO EDGE. 5. AVOID HEAVILY COMPACTING SOIL AROUND VALVE BOXES TO PREVENT COLLAPSE OR

By Appd YYYY.MM.DD


DEFORMATION OF VALVE BOX SIDES.

Davis	VALVE BOX LAYOUT			
	PARKS & COMMUNITY SERVICES			475
	SCALE: NTS	REVISED 2016	DALE SUMERSILLE PARKS & COMMUNITY SERVICES DIRECTOR	175
				24 May 2016

100% CONSTRUCTION DRAWINGS

90% CONSTRUCTION DRAWINGS


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SECTION

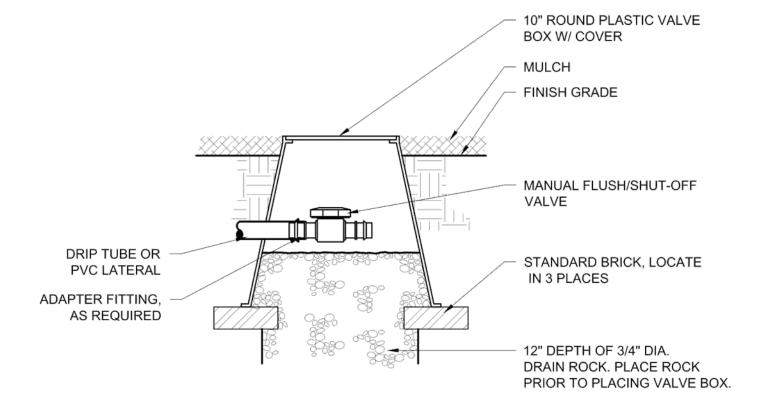24 May 2016


- Dovrio	DRIP MANUAL FLUSH VALVE				
(\Davis	PARKS & COMMUNITY SERVICES			101	
California	SCALE: NTS	REVISED 2016	DALE SUMERSILLE PARKS & COMMUNITY SERVICES DIRECTOR	161	
				24 May 2016	



1. FINAL LOCATION TO BE FIELD DETERMINED BY ARBORIST. 2. FENCE TO BE IN PLACE PRIOR TO START OF CONSTRUCTION

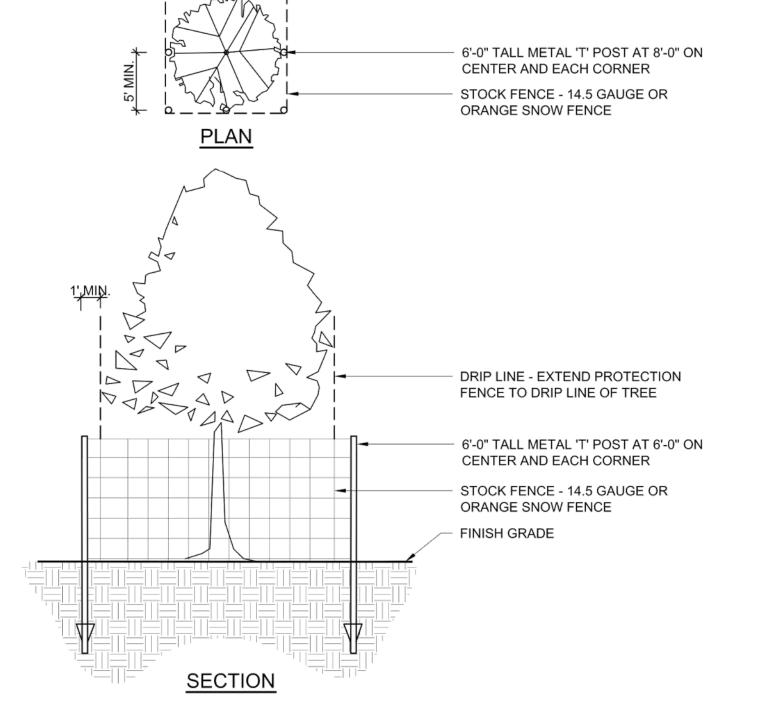
- Dovic	TREE PROTECTION				
11 100 00 1 00	PARKS & COMMUNITY SERVICES			604	
California	SCALE: NTS	REVISED 2016	DALE SUMERSILLE PARKS & COMMUNITY SERVICES DIRECTOR	604	
	_			24 May 2016	

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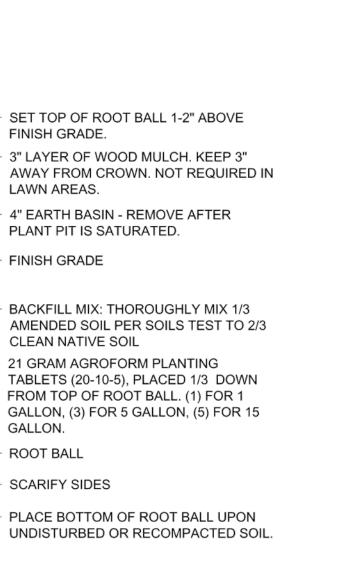
2" WIDER THAN

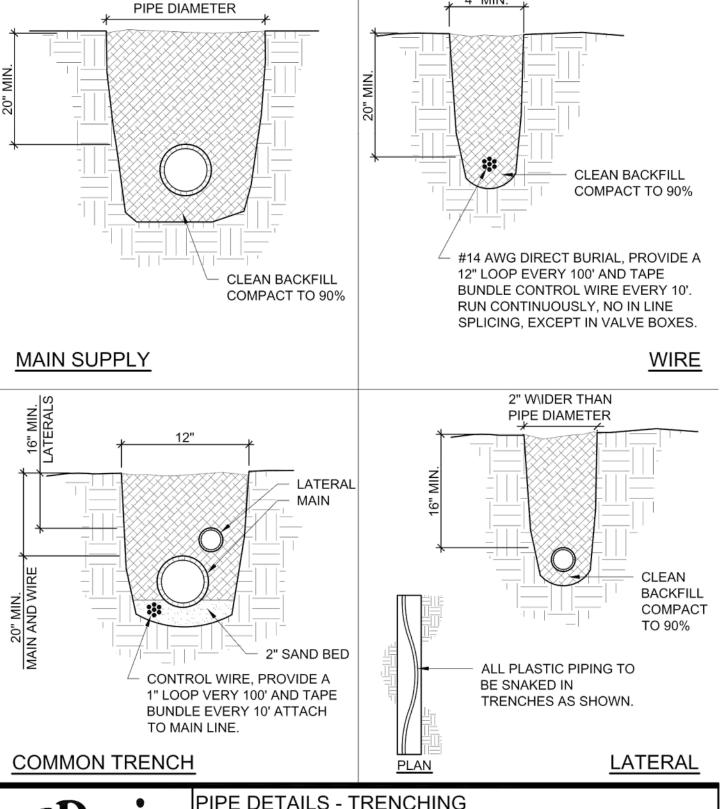
Davis	PIPE DETAILS - TRENCHING			
	PARKS & COMMUNIT	TY SERVICES		170
California	SCALE: NTS	REVISED 2016	DALE SUMERSILLE PARKS & COMMUNITY SERVICES DIRECTOR	170
		-		24 May 2016



SECTION

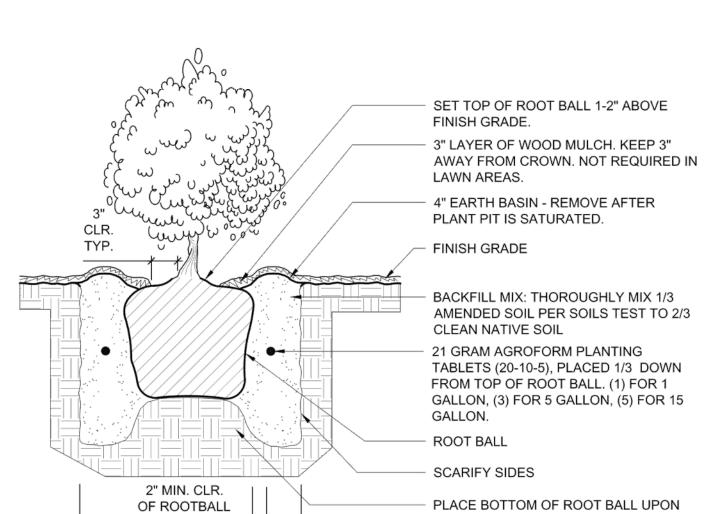2X ROOTBALL DIAMETER



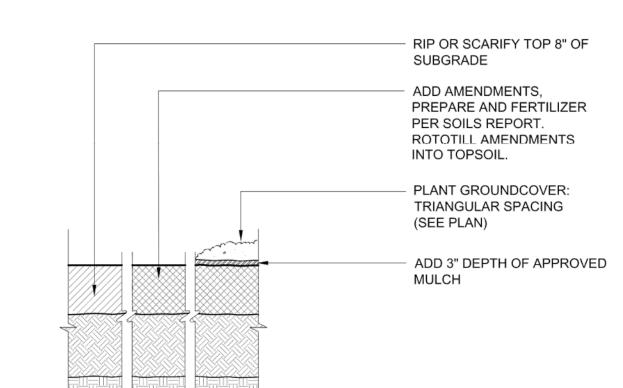

ELECTRICAL WIRING CONNECTORS

REVISED 2016

PARKS & COMMUNITY SERVICES

SCALE: NTS

STEP 1: STRIP WIRES 1/2" FROM ENDS.

STEP 2: APPLY SPRING CONNECTOR OR

CLOCKWISE DIRECTION. TWISTING WIRE

DS-500 BODY. CHECK TO MAKE SURE

SPEARS DRI-SPLICE WIRE NUT DS-500

SPEAR DRI-SPLICE DS-500 BODY

TOGETHER. CRIMP WIRES.

SPEARS DRI-SPLICE DS-500 WIRE NUT IN A

STEP 3: ALIGN WIRE NUT WINGS WITH ARROWS


CONNECTOR HAS BEEN PUSHED PAST LOCKING

DALE SUMERSILLE PARKS & COMMUNITY SERVICES DIRECTO

FINGERS AND IS SEATED AT BOTTOM OF BODY.

AND INSERT FULLY INTO SPEARS DRI-SPLICE

SECTION

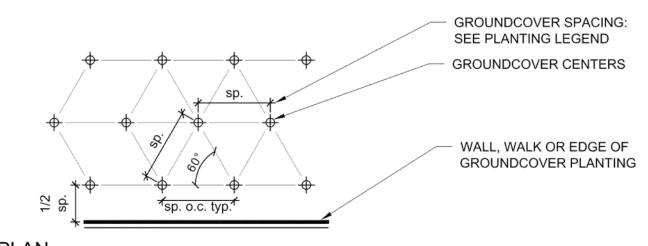

	Dovice	GROUNDCOV	ER PLANTING	3	
605	1 11 1-	PARKS & COMMUNIT	Y SERVICES		606
605	California	SCALE: NTS	REVISED 2016	DALE SUMERSILLE PARKS & COMMUNITY SERVICES DIRECTOR	606
24 May 2016					24 May 2016

REVISED 2016 Client/Project Logo

SHRUB PLANTING

PARKS & COMMUNITY SERVICES



DALE SUMERSILLE PARKS & COMMUNITY SERVICES DIRECTO

Client/Project CITY OF DAVIS

DAVIS COMMUNITY PARK PUMP TRACK

Davis, California
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 2019.03.01

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 File Name: 222011228_LANDSCAPE DETAILS

Scale Project No. **AS SHOWN** 222011228 Revision Sheet Drawing No. L3.1 15 of 17

LANDSCAPE DETAILS

		Permit/Seal
 Appd	2019.03.01 2019.02.06 2018.09.06 YYYY.MM.DD	Signature 10/30/19 Renewal Date 02/04/19 Date


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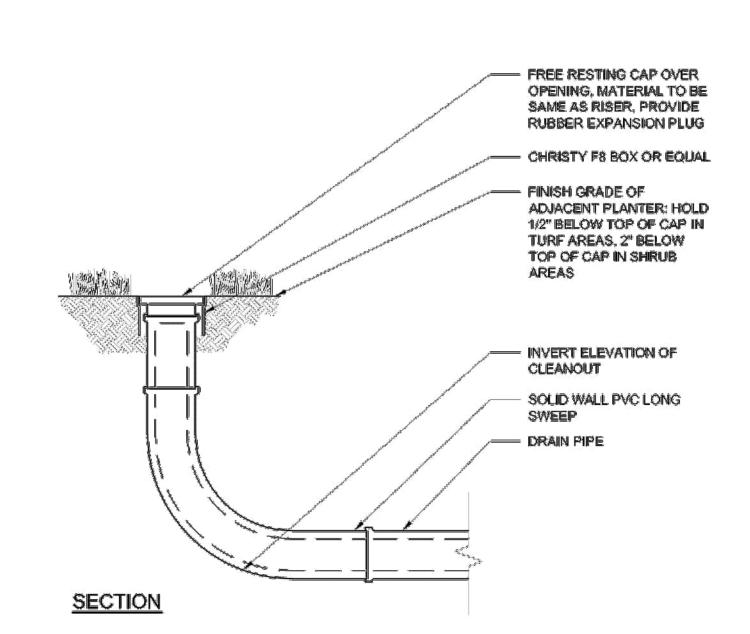
or use for any purpose other than that authorized by Stantec is forbidden

Revision 04-18-23 City Couacil Meeting




- 1. REDDY STAKE TO BE SET 12" AWAY FROM TRUNK ON THE PREVAILING WIND SIDE. FOLLOW MANUFACTURER'S DIRECTIONS.
- 2. TREE TIES MADE OF UV RESISTANT PLASTIC TUBING, PLACED NO HIGHER THAN NECESSARY TO KEEP TREE UPRIGHT. DO NOT ALLOW TREE TO RUB AGAINST STAKE.
- 3. REMOVE NURSERY STAKE WHEN SETTING REDDY STAKE.
- 4. REDDY STAKE AVAILABLE FROM DECORATIONS FROM GENERATIONS, 888.333.3090 OR
- WWW.REDDYSTAKE.COM 5. TREE STAKE TO BE 2"x10" FOR 15 GAL AND 24" BOX, USE GUYING FOR 36" AND LARGER.
- 6. ROOT BALL ANCHOR IS TO BE PER SPECIFICATIONS BY PLATYPUS.


Davis	TREE PLAN	TREE PLANTING			
	PARKS & COMM	UNITY SERVICES		004	
California	SCALE: NTS	REVISED 2016	Bale Sumersule Parks a community services direction	601	

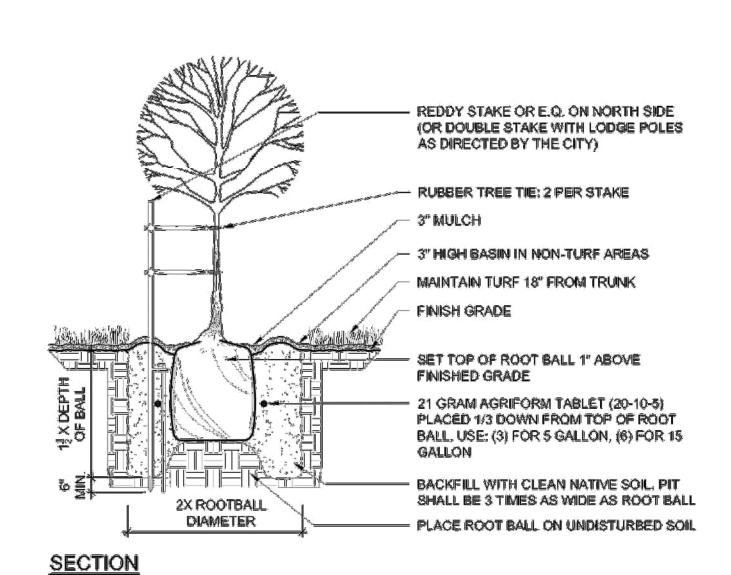

Davis	DRAINAGE	CLEANOUT		
	PARKS & COMM	IUNITY SERVICES		205
	SCALE: NTS	REVISED 2016	BALE SUMERSILLE PARKS A COMMUNITY SERVICES MIRECTION	305
		7	· ·	24 May 2016

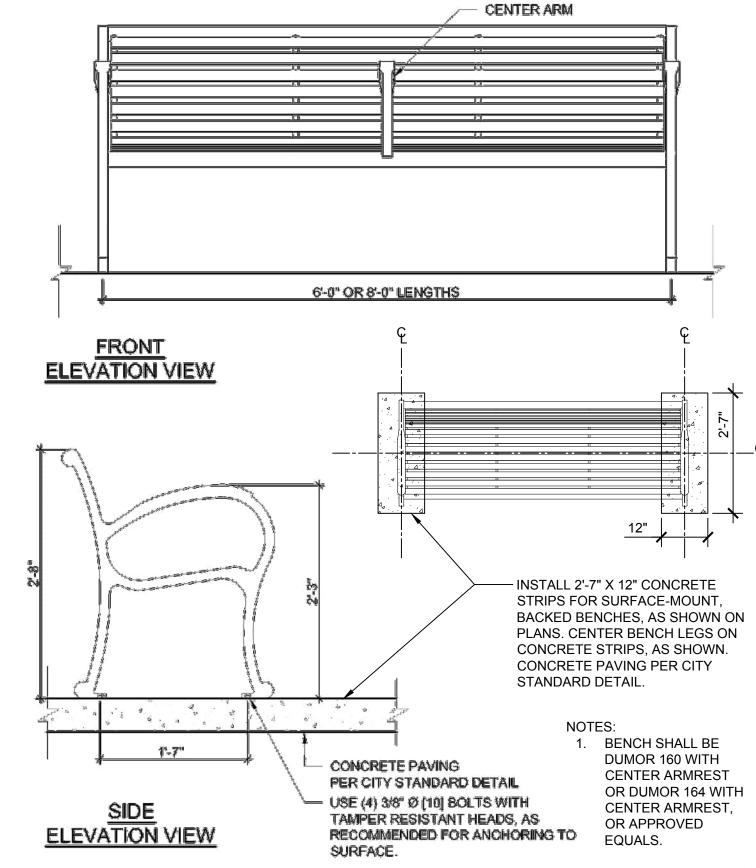



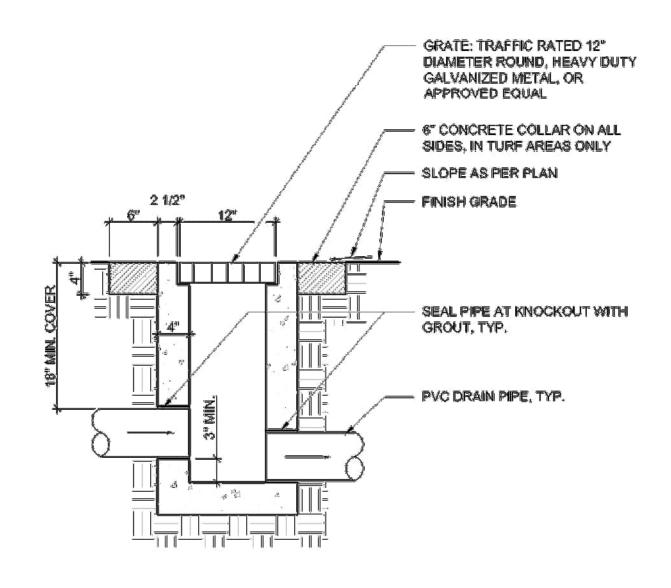


<u>SECTION</u>


- 1. CATCH BASIN SHALL BE JENSEN PRECAST OR APPROVED EQUAL. 2. GROUT SHALL BE NON-SHRINK EPOXY GROUT, MEADOWS
- "SEAL-TIGHT", OR APPROVED EQUAL.

777710	DRAIN INLE	DRAIN INLET (12")						
	PARKS & COMM	UNITY SERVICES		302				
	SCALE: NTS	REVISED 2016	Dave Sumersive Parks a community services impection					
	*	7	*	24 May 2916				


Consultant

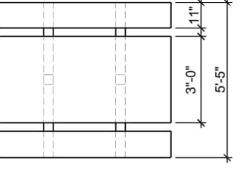



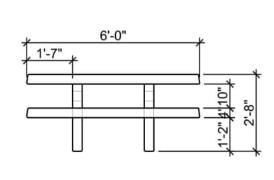

ELEVATION

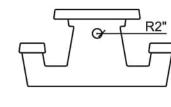

MINIMUM THICKNESS OF ALL AREAS

- TO BE 4 INCHES.
- MINIMUM WEIGHT TO BE 2250 LBS. PICNIC TABLES, BENCHES, BENCH AND TABLE SUPPORTS CAST INTO
- ASSEMBLY REQUIRED. COLORING AGENTS ARE TO BE PURE MINERAL OXIDES AND SHALL

BE MIXED INTEGRALLY WITH


ONE INTEGRAL PIECE. NO

- CEMENT. CONCRETE MIX DESIGN TO INCLUDE 8.5 SACKS PORTLAND CEMENT PER YARD WITH MAXIMUM ROCK SIZE OF
- 6. ALL FORMED SURFACES AND EDGES SHALL BE FULLY ROUNDED AND SMOOTH FINISHED. FINISH OF ALL EXPOSED SURFACES TO HAVE A CONCRETE GRAFFITI-RESISTANT SEALER APPLIED.



PICNIC TABLE	E			
PARKS & COMMUNIT	Y SERVICES		400	
SCALE: NTS	REVISED 2016	DALE SUMERSILLE PARKS & COMMUNITY SERVICES DIRECTOR	403	6

24 May 2016

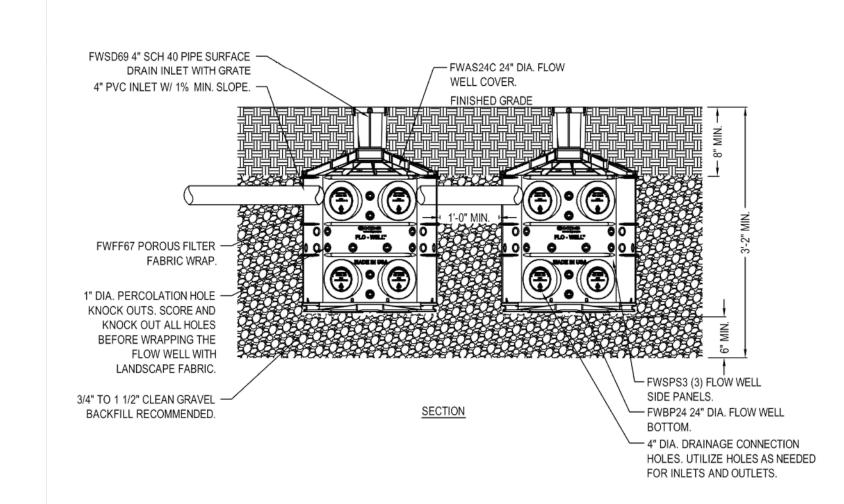

. MUST BE INSTALLED 10' AWAY FROM STRUCTUREOR FOUNDATION.

- 2. FWAS24 KIT DOES NOT COME WITH FWPB24 BTM.
- 3. REFERENCE FLO-WELL CALCULATOR ON NDSPRO.COM 4. INSTALLATION TO BE COMPLETED IN ACCORDANCE WITH MANUFACTURER'S SPECIFICATIONS.
- DO NOT SCALE DRAWING.
- 6. THIS DRAWING IS INTENDED FOR USE BY ARCHITECTS, ENGINEERS, CONTRACTORS, CONSULTANTS AND DESIGN
- PROFESSIONALS FOR PLANNING PURPOSES ONLY. 7. ALL INFORMATION CONTAINED HEREIN WAS CURRENT AT THE TIME OF DEVELOPMENT BUT MUST BE REVIEWED AND APPROVED


Client/Project Logo

- BY THE PRODUCT MANUFACTURER TO BE CONSIDERED ACCURATE. 8. CONTRACTOR'S NOTE: FOR PRODUCT AND COMPANY INFORMATION VISIT www.CADdetails.com/info AND ENTER
- REFERENCE NUMBER 558-036.



FLO-WELL INSTALLATION DETAIL - LOAD CLASS "A" & "B" - GRAVEL INSTALLATION DETAIL, MULTIPLE FLO-WELL - LATERAL CONNECTION

www.ndspro.com/s5 REVISION DATE 09/23/2015

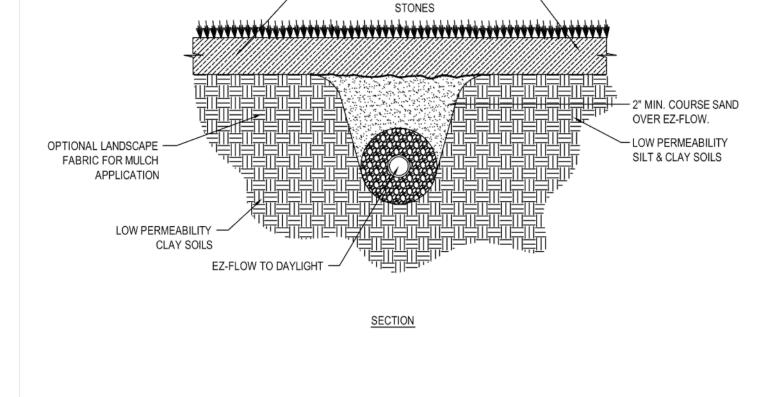

_____ 2" TO 3" LOW CLAY (30%) TOP SOIL, _____

MULCH OR DECO LANDSCAPE


- SWALES ELEVATION SHALL BE 6' MIN. BELOW THE LOWEST ADJACENT ELEVATION 2. BIOWALES SHALL NOT BE CONSTRUCTED UNTIL ALL CONTRIBUTING DRAINAGE AREAS HAVE BEEN STABILIZED
- 3. CO ORDINATE PERFORATED PIPE UNDER DRAINAGE SYSTEMS WITH CIVIL DRAWINGS.
- 4. INSTALLATION TO BE COMPLETED IN ACCORDANCE WITH MANUFACTURER'S SPECIFICATIONS. 5. DO NOT SCALE DRAWING.
- 6. THIS DRAWING IS INTENDED FOR USE BY ARCHITECTS, ENGINEERS, CONTRACTORS, CONSULTANTS AND DESIGN PROFESSIONALS FOR PLANNING PURPOSES ONLY.
- 7. ALL INFORMATION CONTAINED HEREIN WAS CURRENT AT THE TIME OF DEVELOPMENT BUT MUST BE REVIEWED AND APPROVED BY THE PRODUCT MANUFACTURER TO BE CONSIDERED ACCURATE.
- 8. CONTRACTOR'S NOTE: FOR PRODUCT AND COMPANY INFORMATION VISIT www.CADdetails.com/info AND ENTER REFERENCE NUMBER 558-025.

EZFLOW / EZDRAIN SYSTEM



REVISION DATE 09/23/2015

			_				
				3 ISSUE FOR BID 2 100% CONSTRUCTION DRAWINGS			2019.03.01
				1 90% CONSTRUCTION DRAWINGS			2018.09.06
Revision	Ву	Appd	YYYY.MM.DD	Issued	Ву	Appd	YYYY.MM.DD

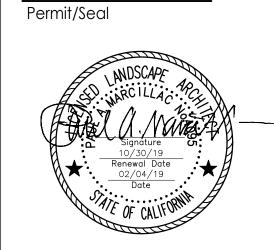



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558-036

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Client/Project CITY OF DAVIS

DAVIS COMMUNITY PARK PUMP TRACK

Davis, California

File Name: 222011228_LANDSCAPE DETAILS

558-025

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 2019.03.01


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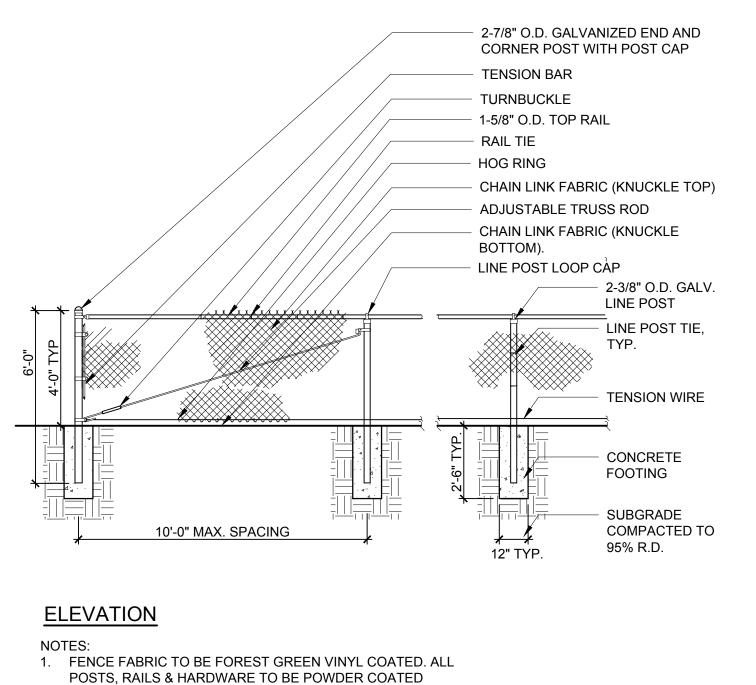
Project No. Scale **AS SHOWN** 222011228


LANDSCAPE DETAILS

Revision Sheet Drawing No. L3.2 16 of 17


04-18-23 City Council Meeting




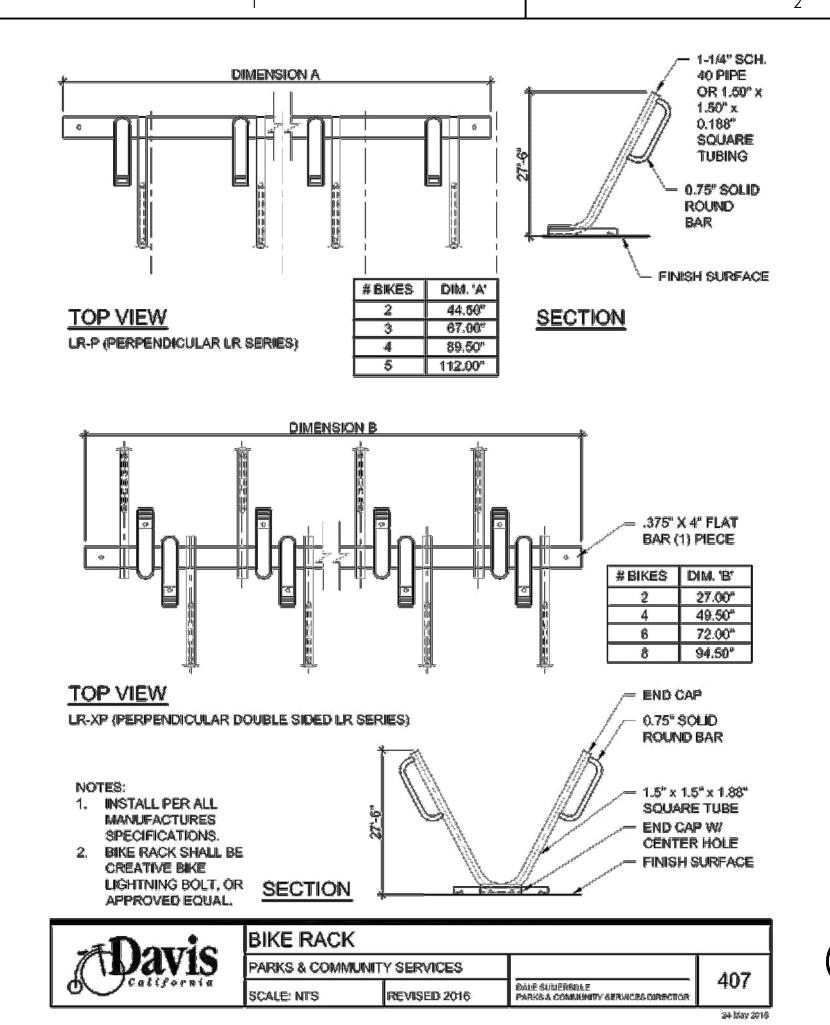

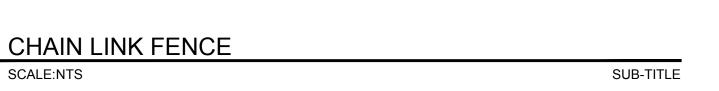


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FENCING FOR REVIEW AND APPROVAL PRIOR TO

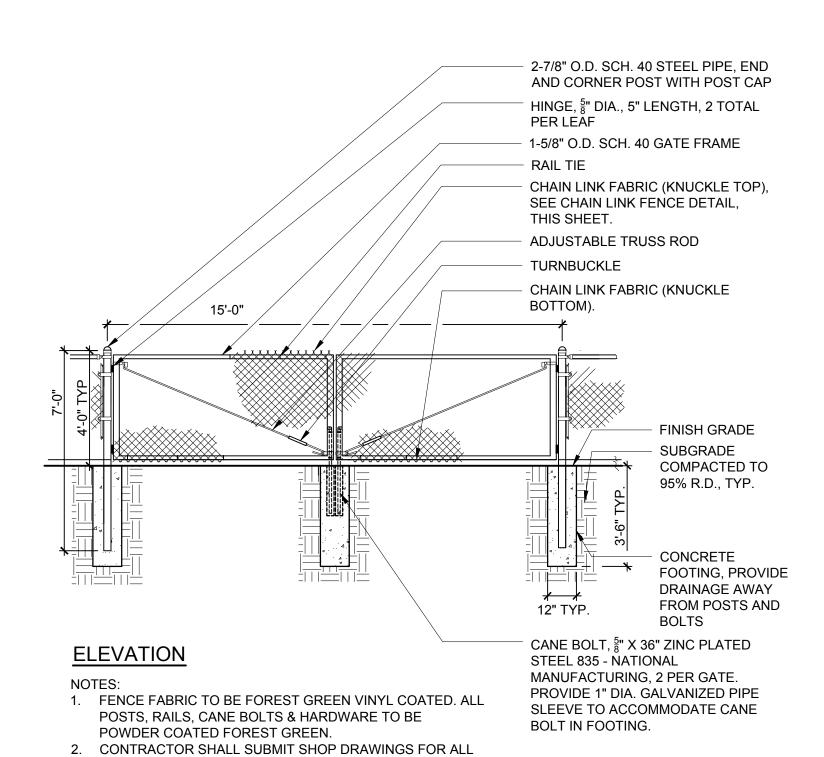FABRICATION.

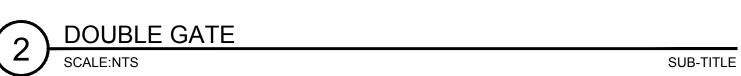

ELEVATION


NOTES:
1. FENCE FABRIC TO BE FOREST GREEN VINYL COATED. ALL POSTS, RAILS &

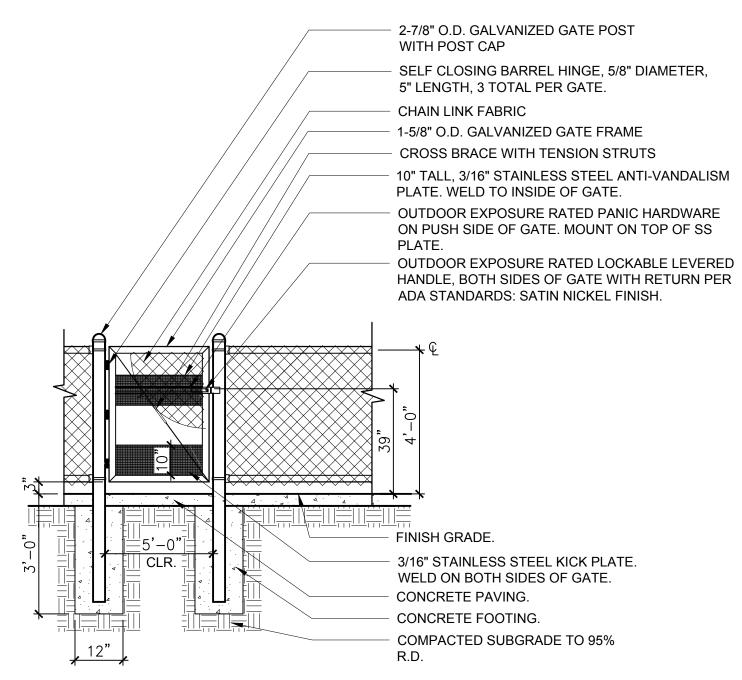
- HARDWARE TO BE POWDER COATED FOREST GREEN.

 2. CONTRACTOR SHALL SUBMIT SHOP DRAWINGS FOR ALL FENCING FOR REVIEW AND
- CONTRACTOR SHALL SUBMIT SHOP DRAWINGS FOR ALL FENCING FOR REVIEW AN APPROVAL PRIOR TO FABRICATION.
- 3. MAXIMUM EFFORT NECESSARY TO OPERATE GATE SHALL NOT EXCEED 5 LBF.



SUB-TITLE

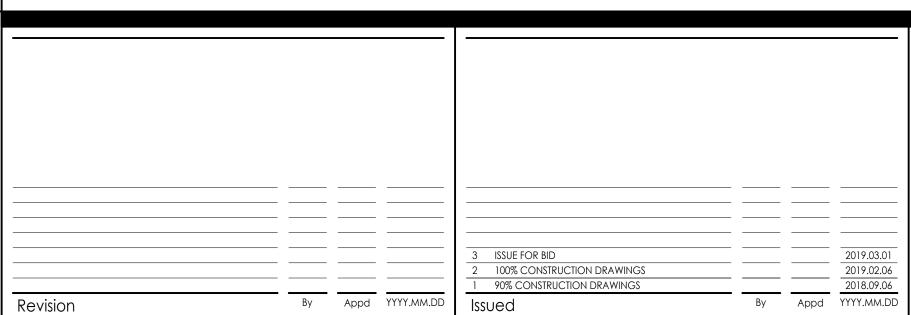

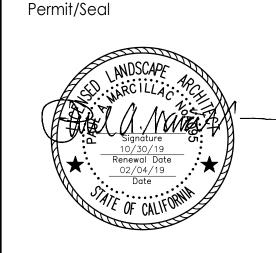

FOREST GREEN.

FABRICATION.

2. CONTRACTOR SHALL SUBMIT SHOP DRAWINGS FOR ALL

FENCING FOR REVIEW AND APPROVAL PRIOR TO

Stantec

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Client/Project Logo

Client/Project
CITY OF DAVIS

DAVIS COMMUNITY PARK PUMP TRACK

Davis, California

File Name: 222011228_LANDSCAPE DETAILS

LANDSCAPE DETAILS

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Project No.

222011228

Revision Sheet Drawing No.


1 17 of 17 L3.3


Revision


By Appd YYYY.MM.DD Issued


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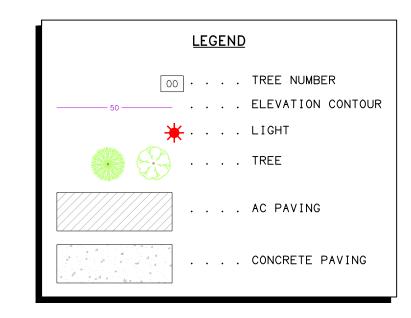
04A - 2



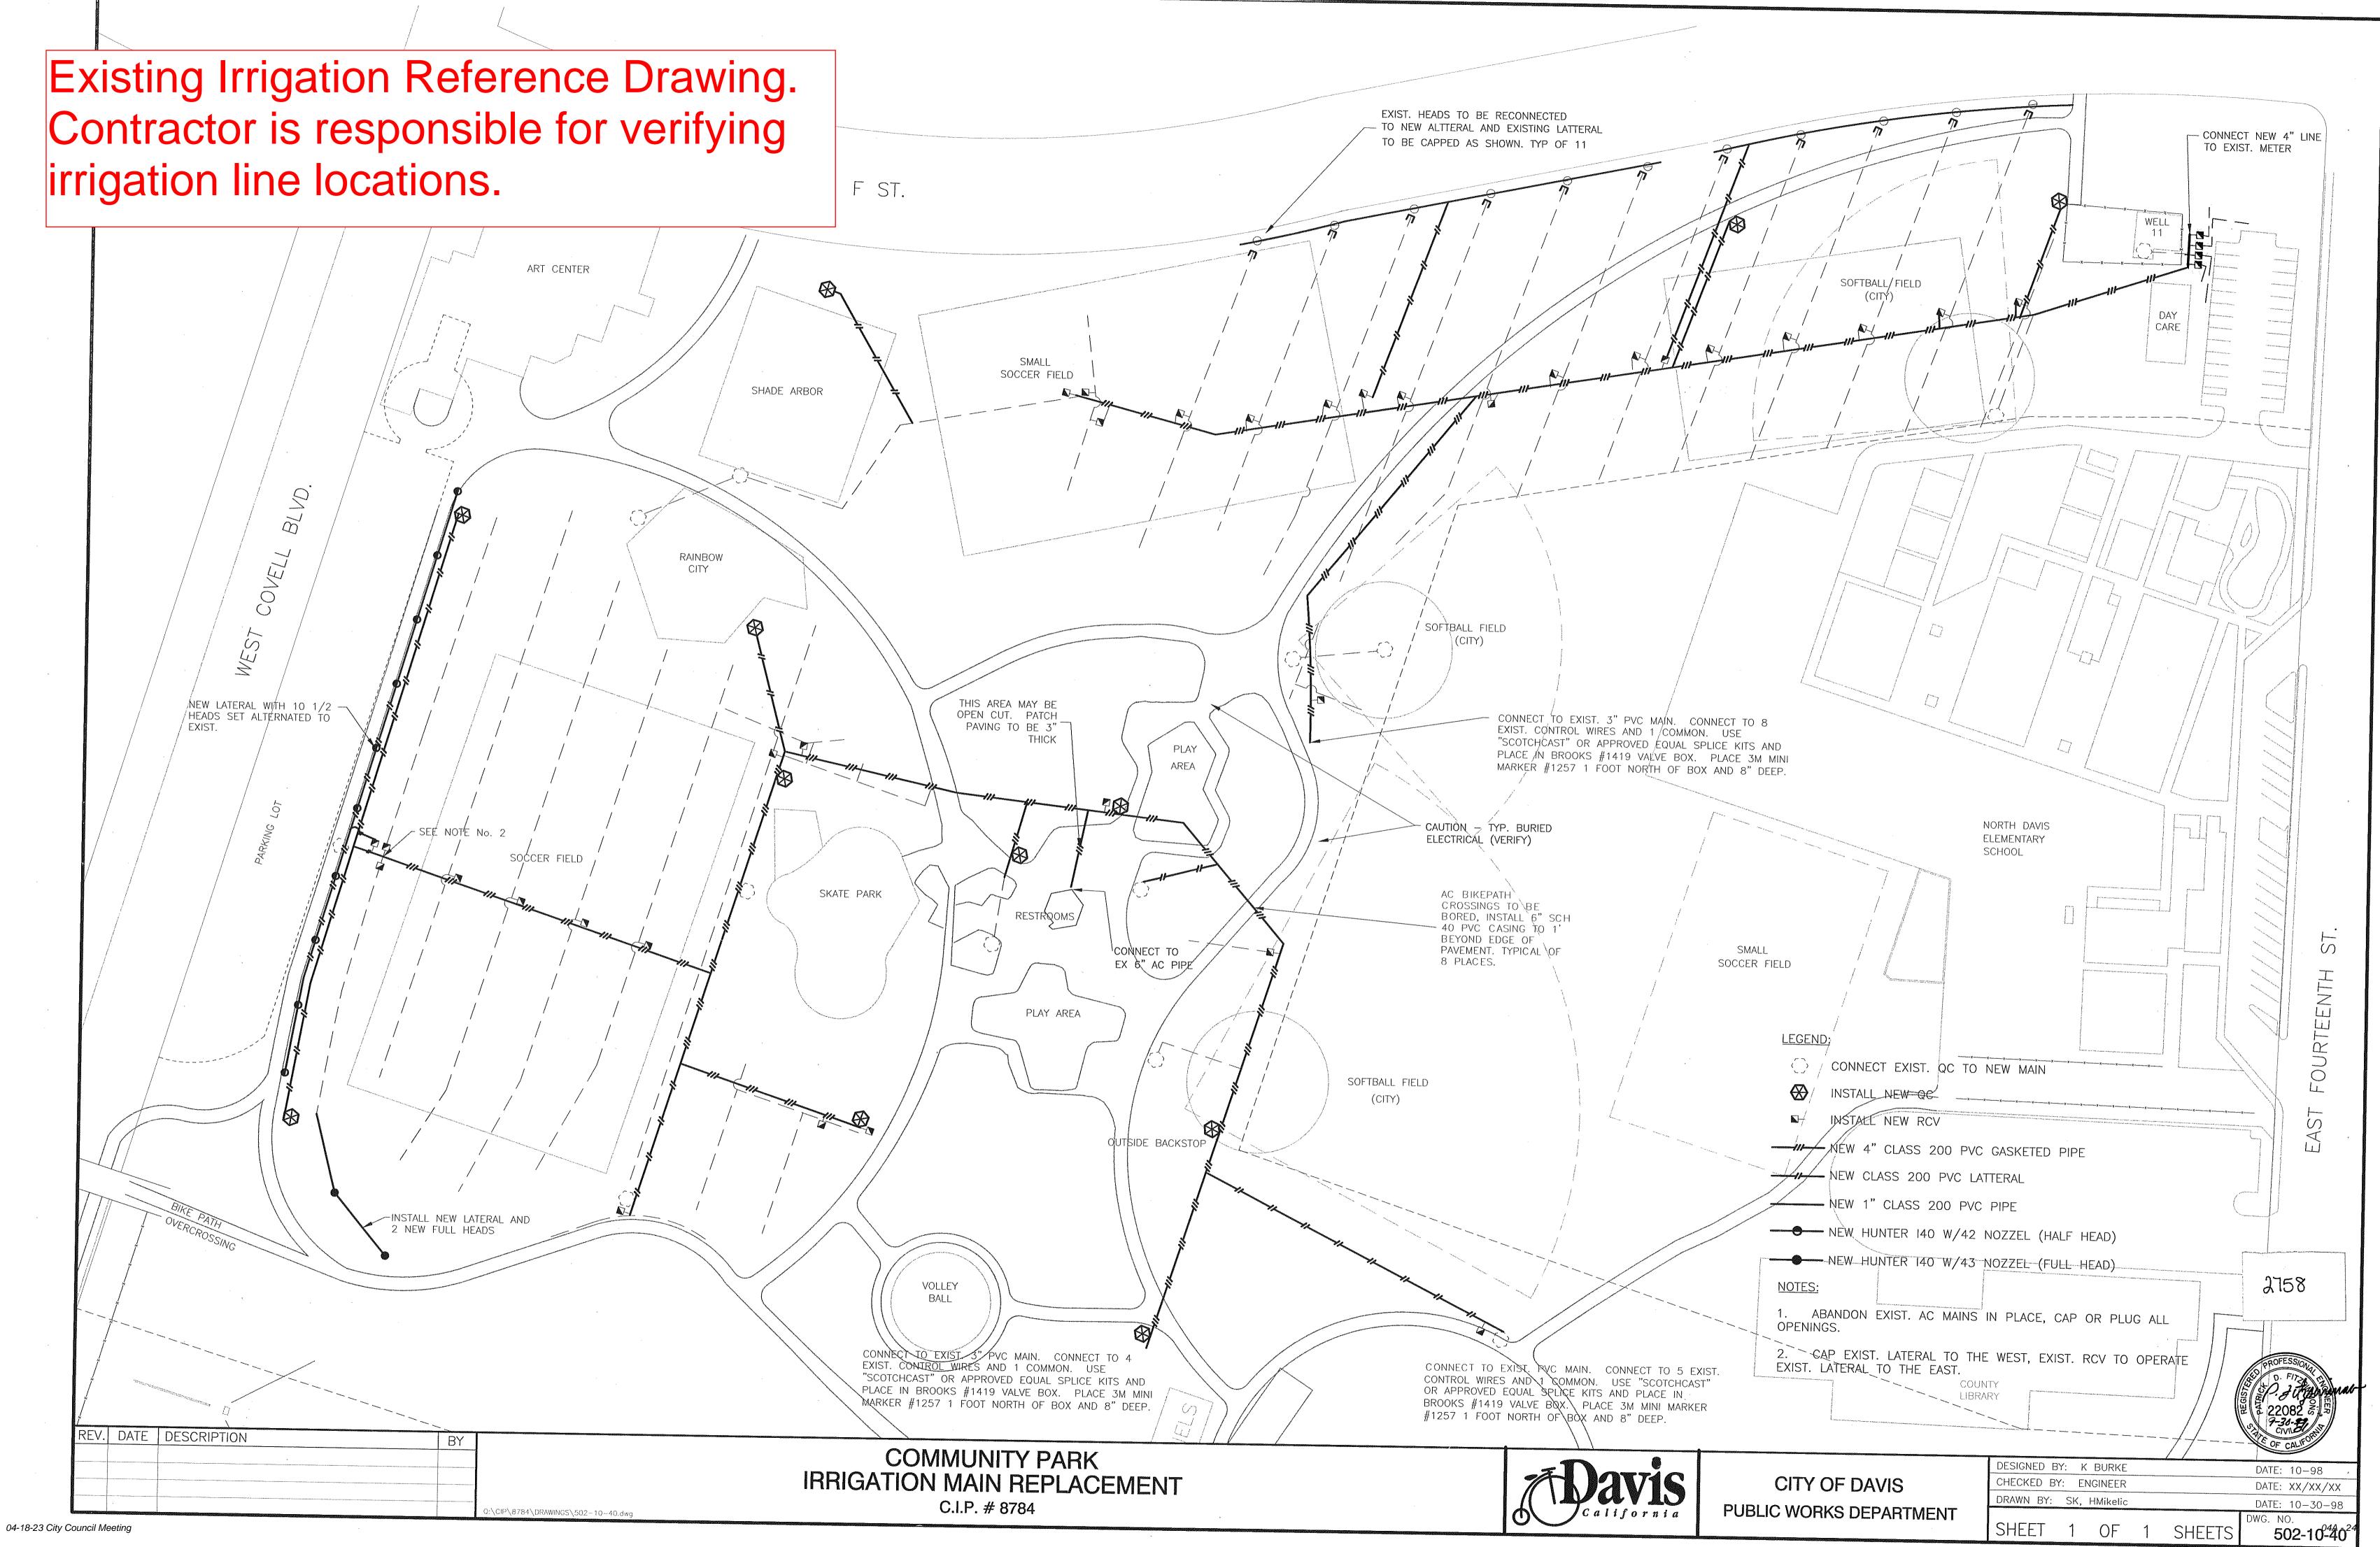

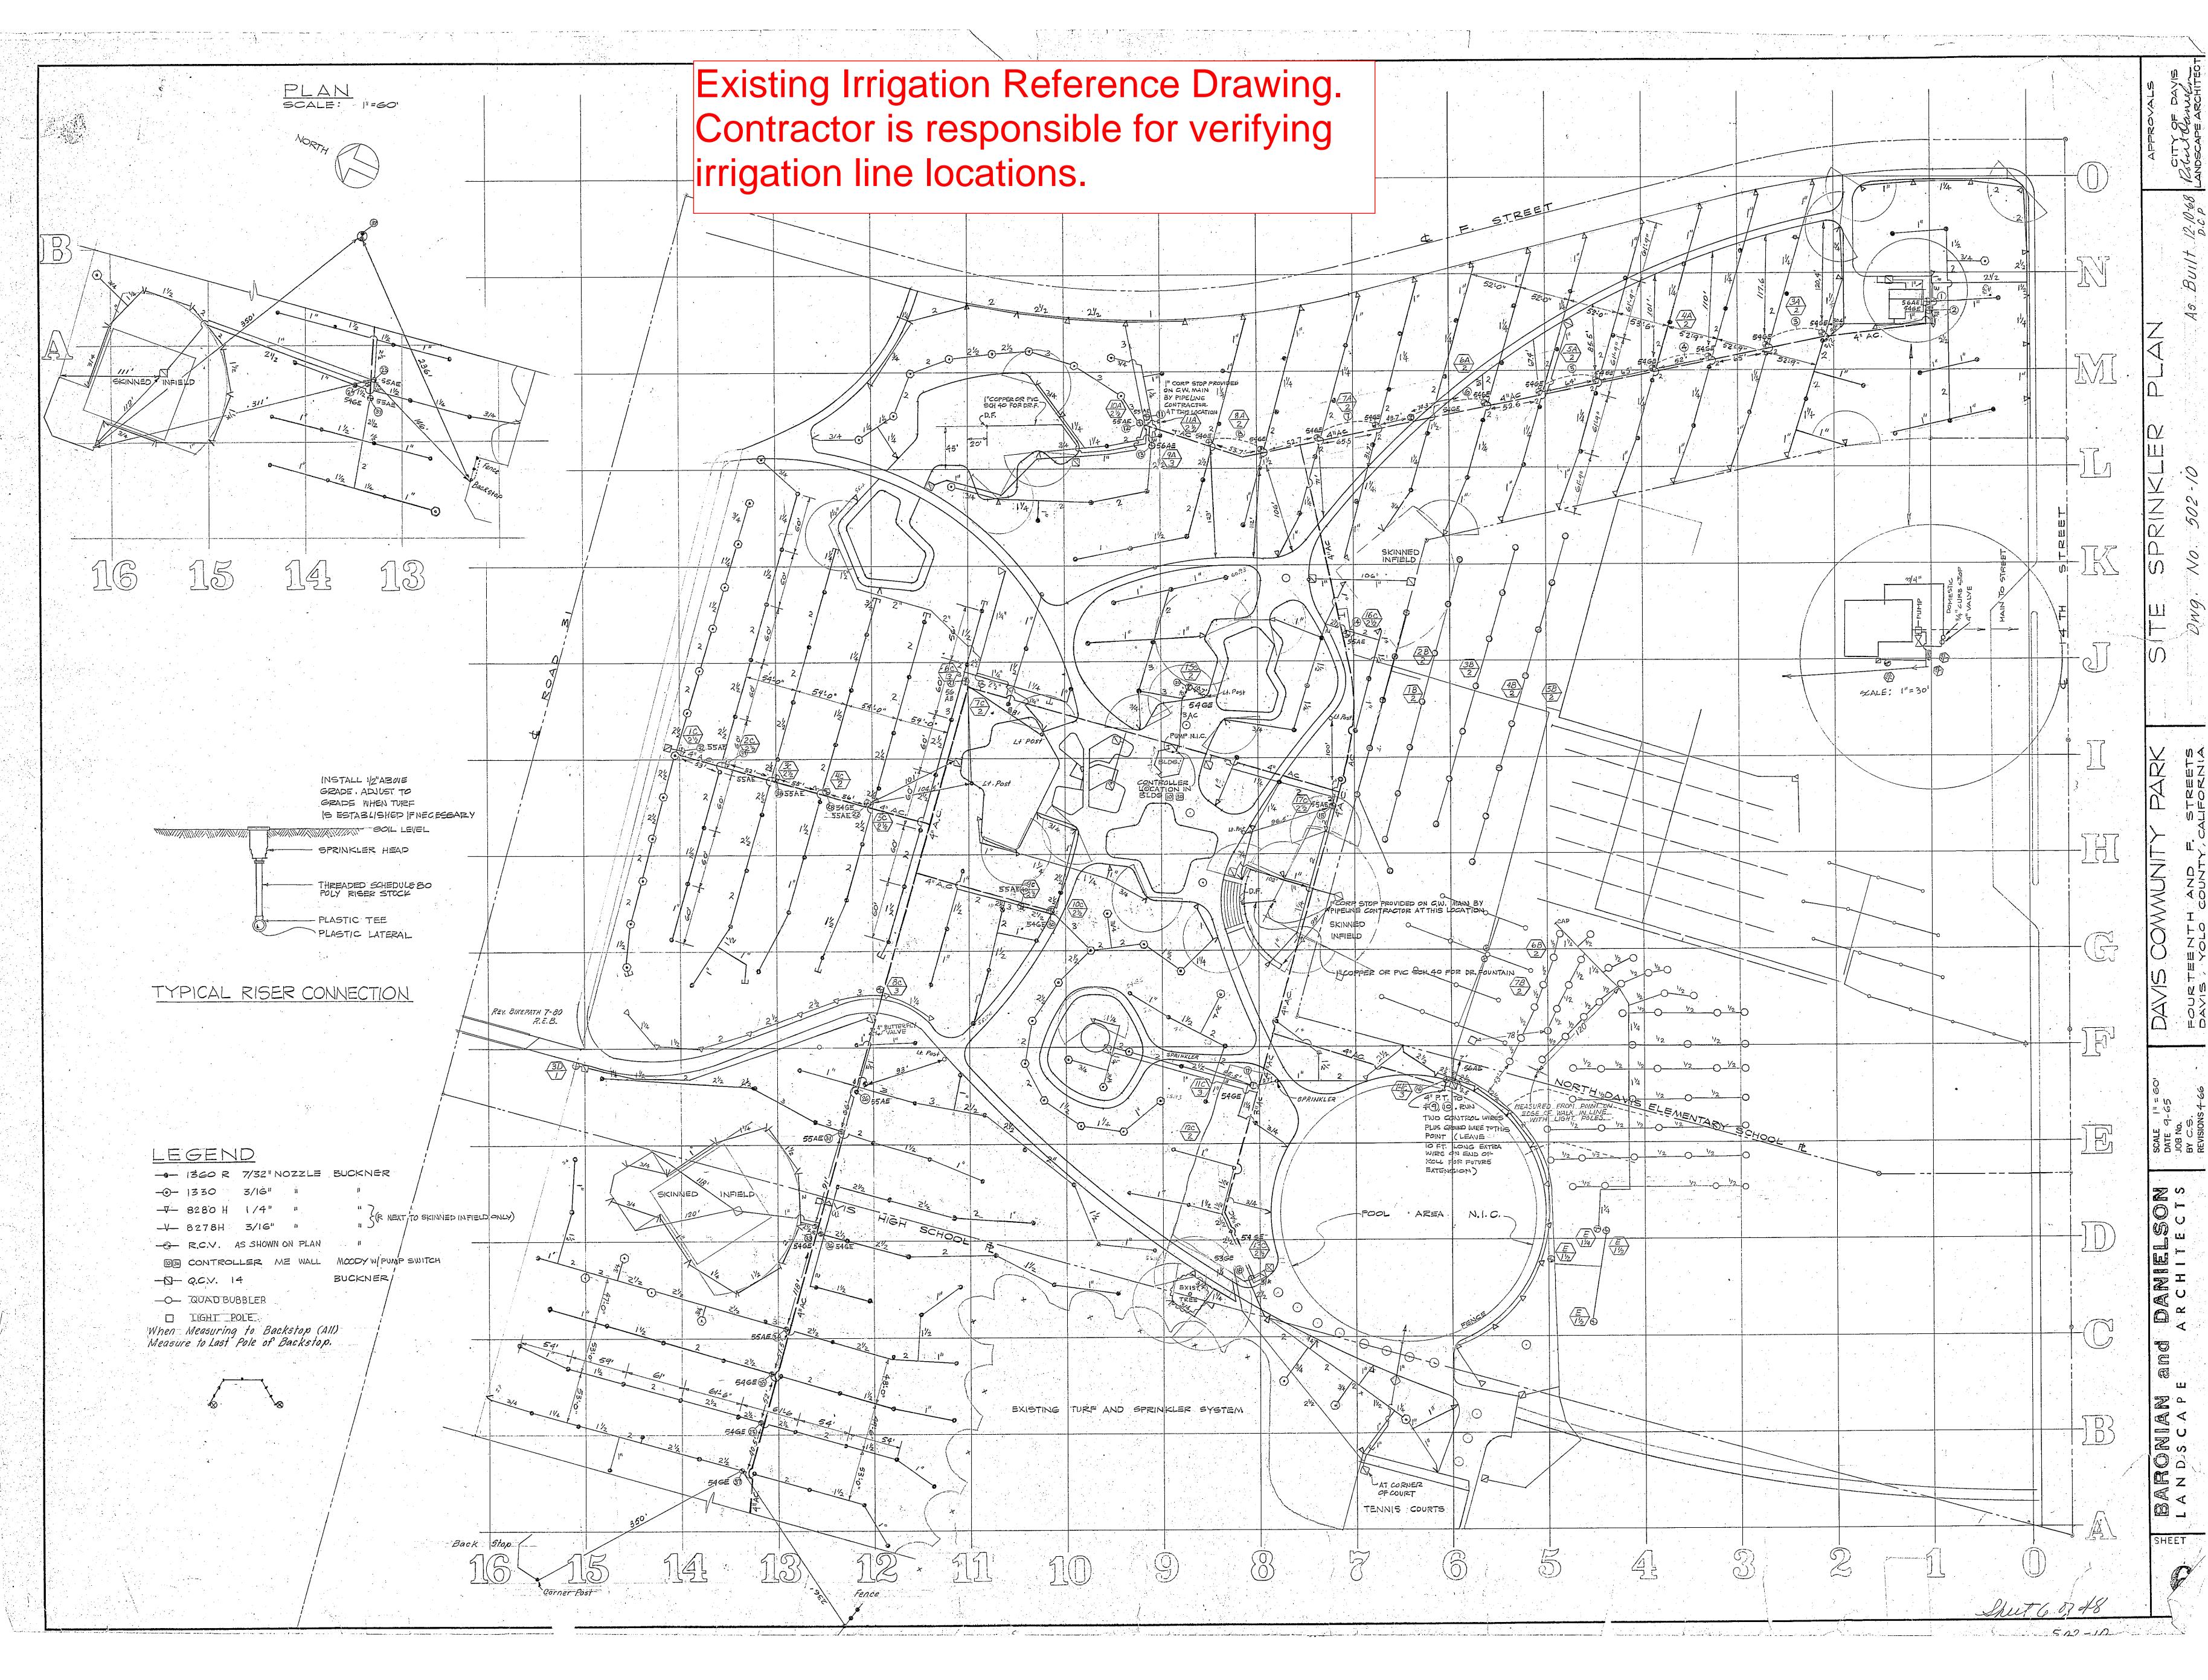

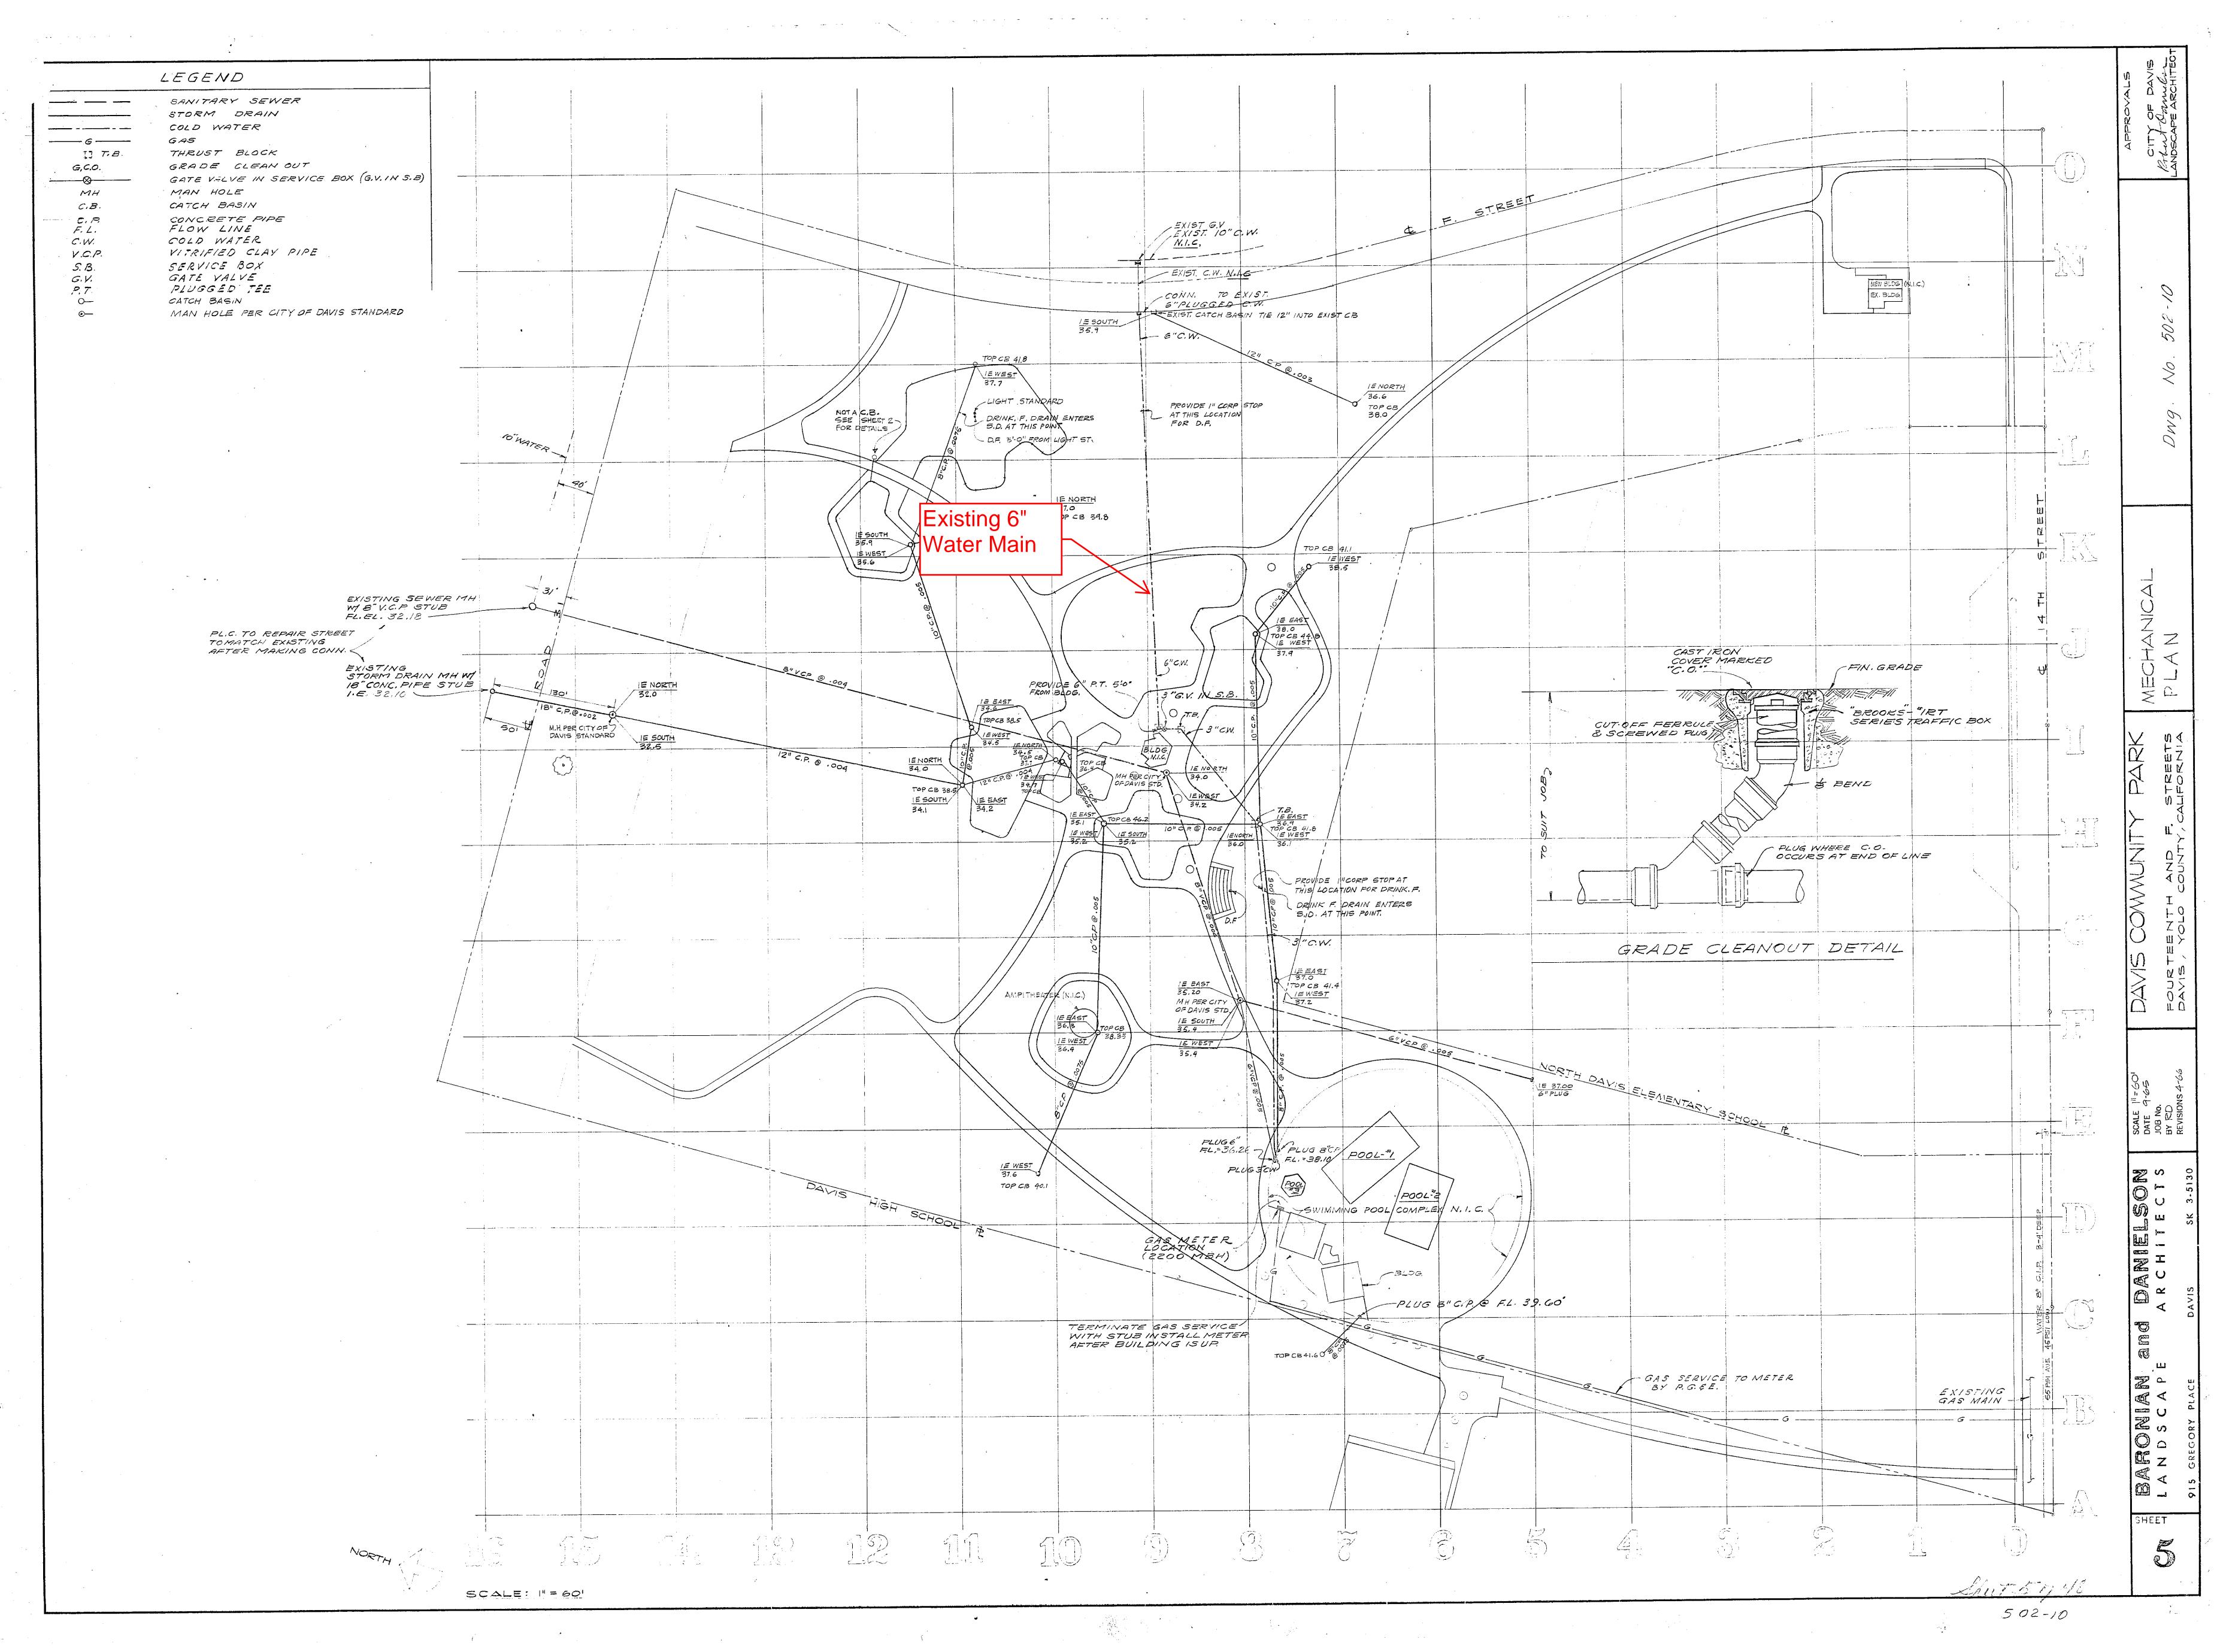

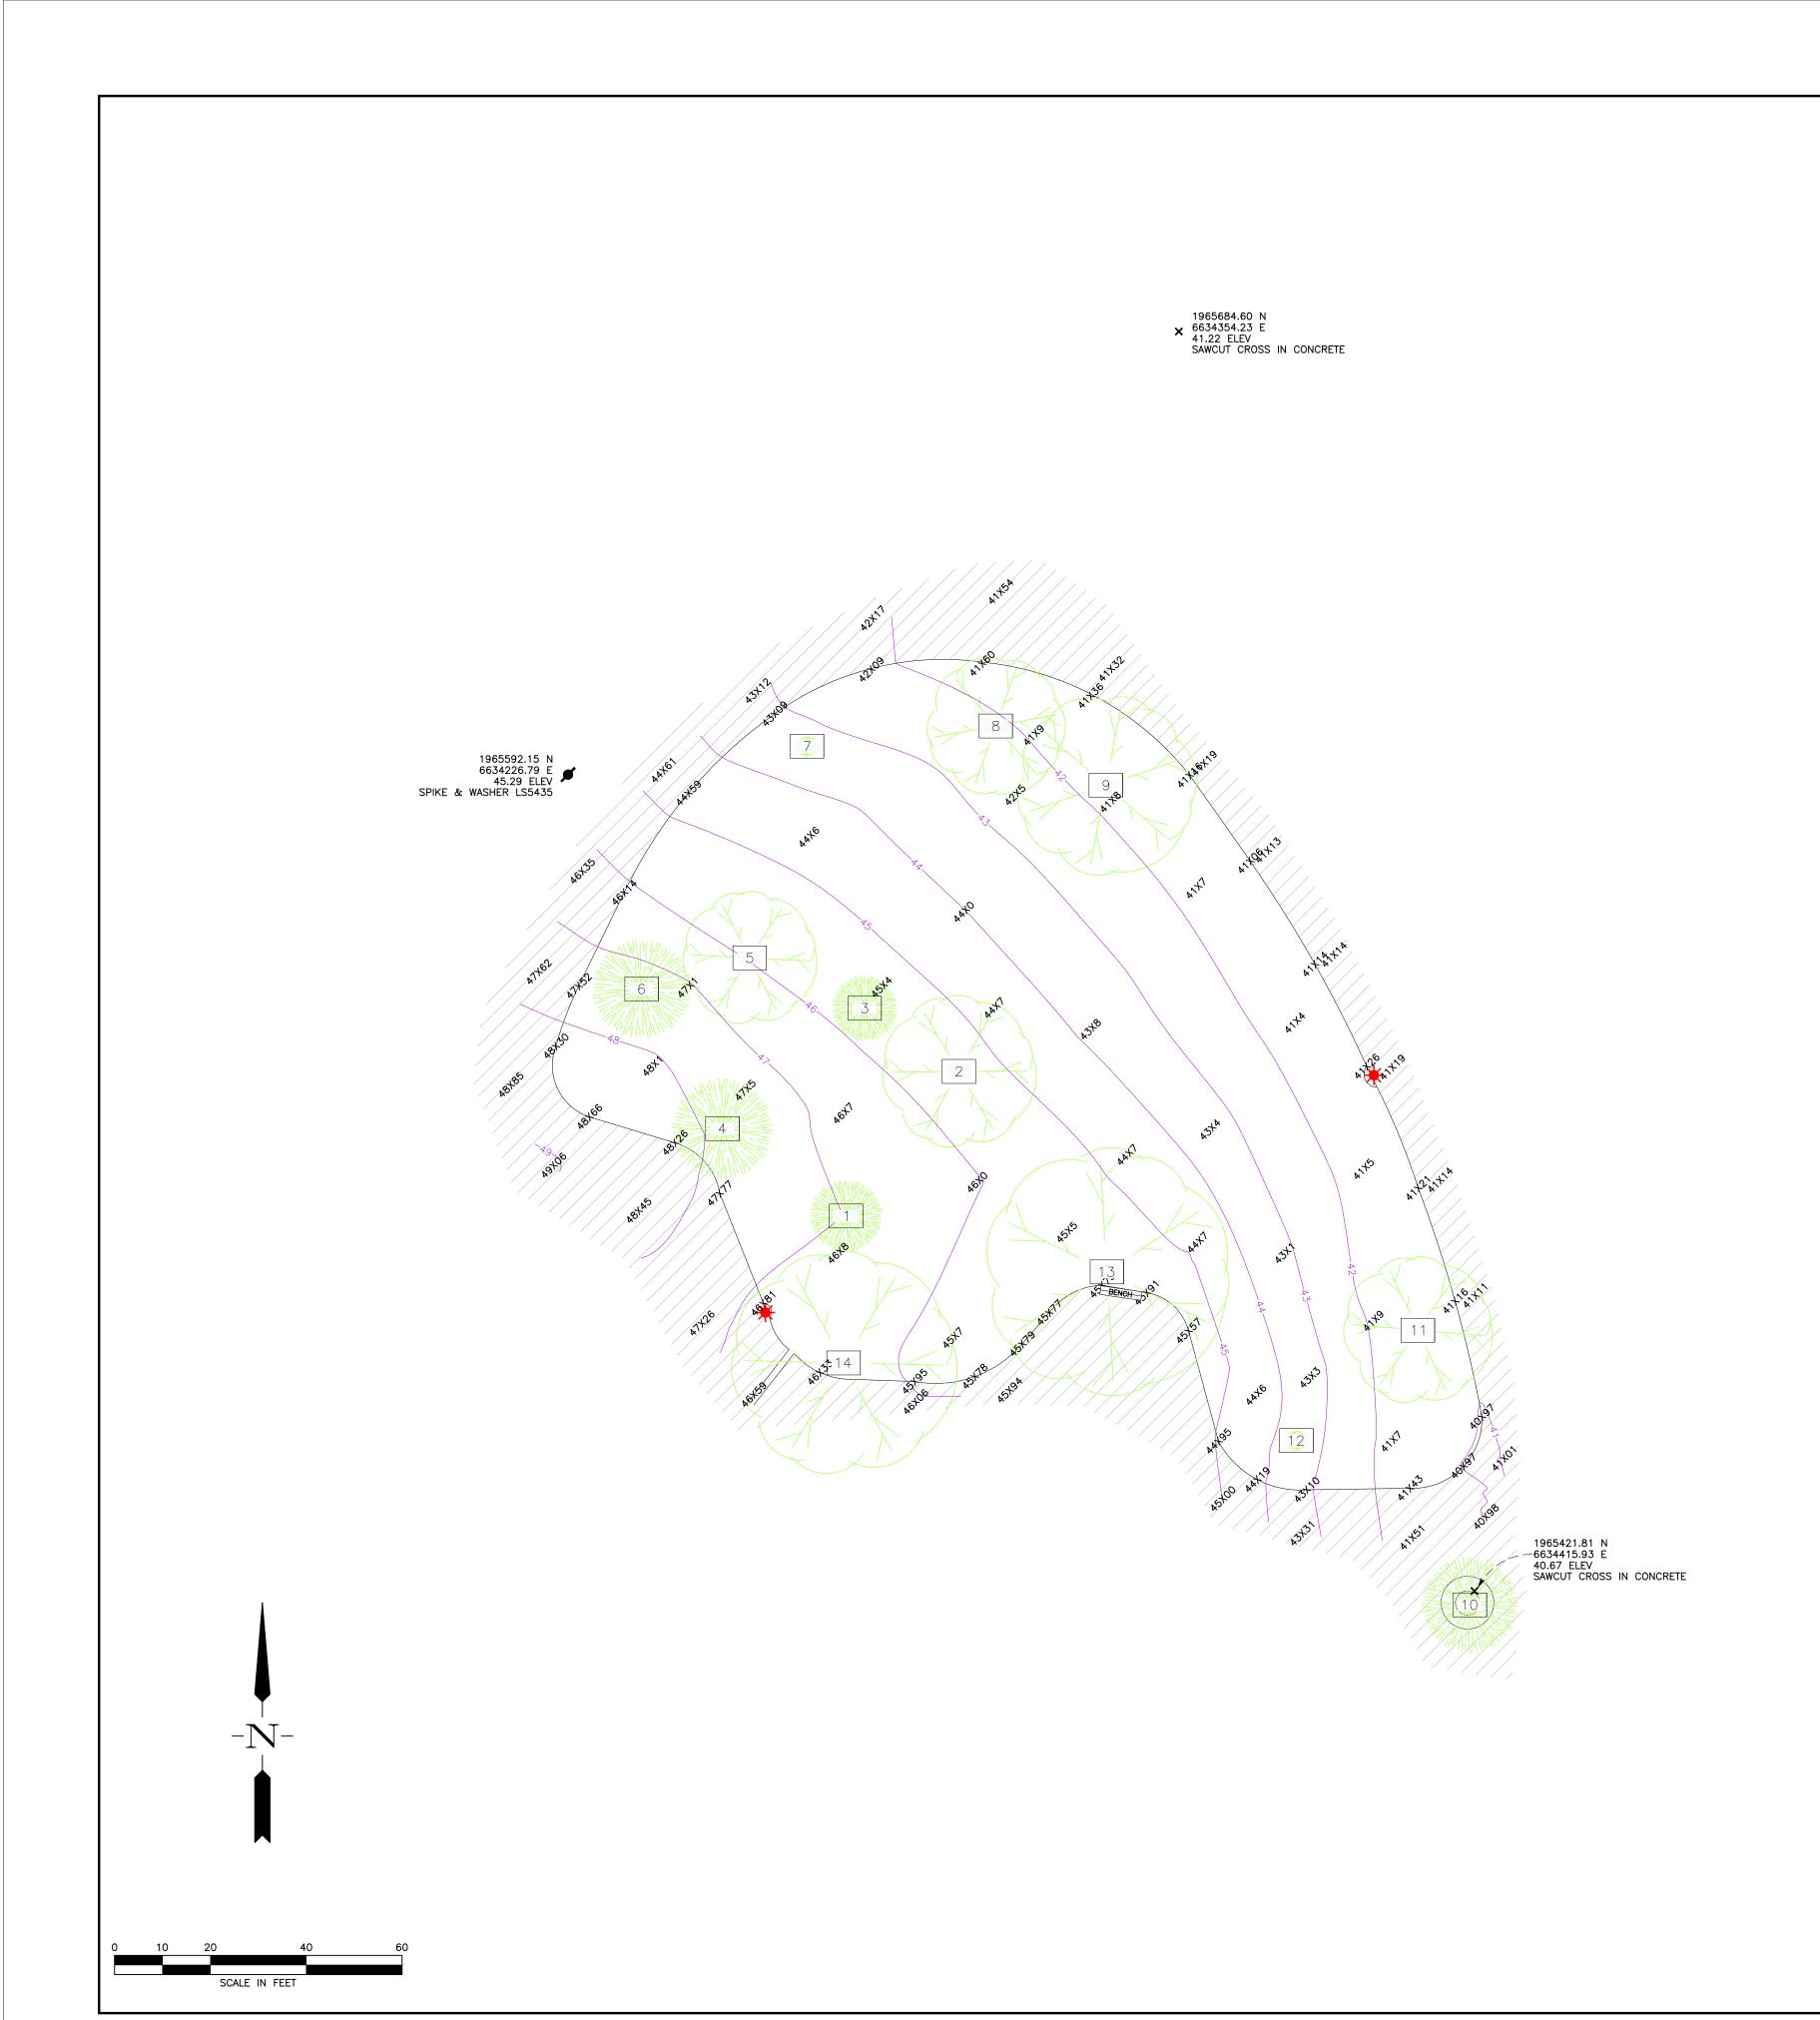

TREE LEGEND					
TREE NO.	SIZE	TYPE	ELEV		
1	8"	REDWOOD	47. 0		
2	15"	UNIDENTIFIED	45. 5		
3	9"	REDWOOD	45. 6		
4	10"	PINE	47. 8		
5	8"	CHINESE ELM	45. 9		
6	8"	PINE	47. 5		
7	1"	UNIDENTIFIED	43. 3		
8	24"	UNIDENTIFIED	42. 2		
9	12"	UNIDENTIFIED	41. 6		
10	12"	PINE	40. 6		
11	20"	UNIDENTIFIED	41. 4		
12	1"	UNIDENTIFIED	43. 6		
13	24"	UNIDENTIFIED	45. 7		
14	18"	UNIDENTIFIED	46. 2		

SURVEY CONTROL

ELEVATION DATUM: NAVD88, AS ESTABLISHED BY RTK OBSERVATIONS FROM STATION UCD1 (PID A14467, -0.05 FOOT ELLIPSOID HEIGHT PER CSRS EPOCH 2017.50) AND GEOID 12B.



MEMORANDUM OF UNDERSTANDING

This Memorandum of Understanding ("MOU") regarding the **Community Park Pump Track** is made and entered into this 18th day of April 2023, by and between the **City of Davis**, a municipal corporation under the laws of the State of California ("City"), and **Davis Bike Park Alliance**, a non-profit 501(c)(3) organization ("DBPA"). City and Licensee are sometimes referred herein as "Party" and collectively as "Parties".

RECITALS

Whereas, the DBPA, a nonprofit 501(c)(3) organization, has expressed interest in providing volunteer labor to assist in maintaining the Pump Track.

Whereas, the parties to this MOU agree that this MOU supersedes and replaces any prior MOU, and any prior MOU is of no further force or effect.

UNDERSTANDINGS

Now Therefore, The City of Davis and DBPA agree as follows:

SCOPE OF SERVICES AND TERMS

- 1. The City intends to construct and operate the Pump Track at Community Park in a manner as set forth in the plans and specifications for the Pump Track as developed and approved by the City. The City estimates that the work described in this section will be complete within nine (9) months of the date of this MOU, provided however that the City has no obligation to DBPA to complete the Pump Track within the time frame provided herein. Upon completion of construction of the Pump Track, the City will be the sole operator of the Pump Track and DBPA will be responsible for maintenance of the Pump Track in accordance with Exhibit "A" to this MOU.
- 2. Upon commencement of the Term of this MOU, as described below, the DBPA shall perform the tasks detailed in Exhibit "A," which is fully incorporated herein.
- 3. Upon commencement of the Term of this MOU, as described below, the City shall perform the tasks detailed in Exhibit "B," which is fully incorporated herein.
- 4. The term of this MOU shall begin once the Notice of Completion for the Pump Track is recorded with the County, and shall be one year with an automatic renewal at the end of each year unless terminated or amended.

5. After the initial term, the DBPA may terminate the MOU with a ninety day written notice delivered to the City. Notice must be delivered by certified U.S. mail to:

City of Davis Attn: City Manager 23 Russell Boulevard Davis, CA 95616

6. The City may terminate this MOU for any reason with a ninety-day written notice delivered to the DBPA. Notice must be delivered by certified U.S. Mail to:

Davis Bike Park Alliance Attn: Ken Bradford

Davis, CA 95616

- 7. The MOU may be amended by a written agreement signed by both parties.
- 8. The DBPA will meet with the City annually to review the maintenance schedule, and tasks as detailed in Exhibits "A" and "B."
- 9. The DBPA shall notify the City in writing of any plans to alter the layout or features of the pump track.
- 10. The DBPA affirms and shall ensure that all volunteer services are offered freely and without pressure and coercion, direct or implied, from an employer.
- 11. None of DBPA's volunteers shall be otherwise employed for compensation at any time in any construction, alteration, demolition, installation, repair, or maintenance work on the Pump Track.
- 12. DBPA, and its volunteers hereby agrees to and shall complete and sign the City of Davis Volunteer Sign-In sheet prior to any volunteer service.
- 13. To the fullest extent permitted by law, the parties to this MOU shall indemnify, defend, and hold harmless each other from any and all liability, claims, suits, actions, proceedings, losses, expenses, injuries or damages, of any kind whatsoever, including attorneys' fees, court costs, and any other costs of any nature, without restriction, whether actual, alleged or threatened, incurred in relation to, as a consequence of, or arising out of, the performance of this MOU, and attributable to the fault of the other. Following a determination of the percentage of fault and or liability by agreement between the parties or a court of

competent jurisdiction, the party responsible for liability to the other will indemnify the other party to this MOU for the percentage of liability determined.

The terms of this Section 12 shall survive the expiration or termination of this MOU.

SIGNATURES ON FOLLOWING PAGE

SIGNATURE PAGE FOR MEMORANDUM OF UNDERSTANDING BETWEEN THE CITY OF DAVIS AND DAVIS BIKE PARK ALLIANCE

This MOU is entered into the 18th day of April 2023.

CITY OF DAVIS	DAVIS BIKE PARK ALLIANCE
Ву:	By:
Michael Webb, City Manager	
	Its:
	Printed Name:

Exhibit "A" Davis Bike Park Alliance Maintenance Services

- Participate in and provide support for routine maintenance of the Pump Track, including patching holes, and compaction of dirt to re-shape the Pump Track back to its original configuration.
- 2. Monitor, and inform the City of any material damage, and proposed changes to the Pump Track. City approval is required prior to any changes to the Pump Track.
- 3. Recruit and coordinate volunteers to assist in maintaining the Pump Track.
- 4. Assist the City with creation and education of Pump Track rules and etiquette.
- 5. Watering of the Pump Track on an as needed basis to minimize the amount of dirt eroded by wind, and maintain proper soil compaction.
- 6. Assist with keeping the track clean by picking up trash as needed, raking, and piling leaves during work parties, asking participants to clean-up after themselves and respect the park space.
- 7. Assist with weed removal, and plant pruning, which involves hand removal of weeds, and occasional plant pruning of plants encroaching onto the Pump Track during work parties. Leaves, prunings, and weeds will be placed in a pile, bags or tarps, and use of pesticides is prohibited.
- 8. Inspection and maintenance of dirt features by filling, packing, and smoothing pits, holes, gouges, erosion, etc. for all riding surfaces.
- 9. Removal of hazardous debris, trash, rocks, etc. throughout the Pump Track on riding surfaces.
- 10. Inspection, and alerting the City of any safety issues, vandalism and non-approved Pump Track modifications.
- 11. Inspection, and alerting the City of any drainage issues at the Pump Track.
- 12. Assist with periodic closure of the Pump Track due to weather conditions.
- 13. Perform regularly scheduled maintenance at designated intervals as indicated by the table below:

Table 1: Maintenance Schedule

DBPA Task	As Needed	Weekly	Monthly	Annually
Watering of the Pump Track	X			
Weed Removal, and Plant Pruning	X			
Patching of Track	X		X	
MOU Review with City				Х

Exhibit "B" City of Davis Maintenance Services

- 1. Emptying waste bins near the Pump Track.
- 2. Raking and piling of leaves.
- 3. Weeding and plant pruning.
- 4. Supplying of additional dirt for repairs to the pump track.
- 5. Maintenance and repair of perimeter fence.
- 6. Irrigation, and drainage system maintenance and repair.
- 7. Site plant replacement, and tree trimming.
- 8. Establish, install and maintain appropriate signage.
- 9. Periodic closure of the Bike Park due to weather conditions.